



FILE: L-W-AFP
COMM: REvised
SHEET: DATE: 10/21/91
A-1 DRAWN: SMW




LINEWEAVER APARTMENT ANNEX CORPORATION
HARRISONBURG, VIRGINIA

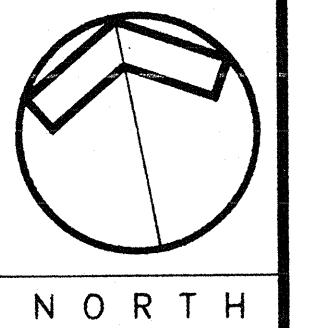


NEW GROUND FLOOR PLAN
NORTH

REVISIONS

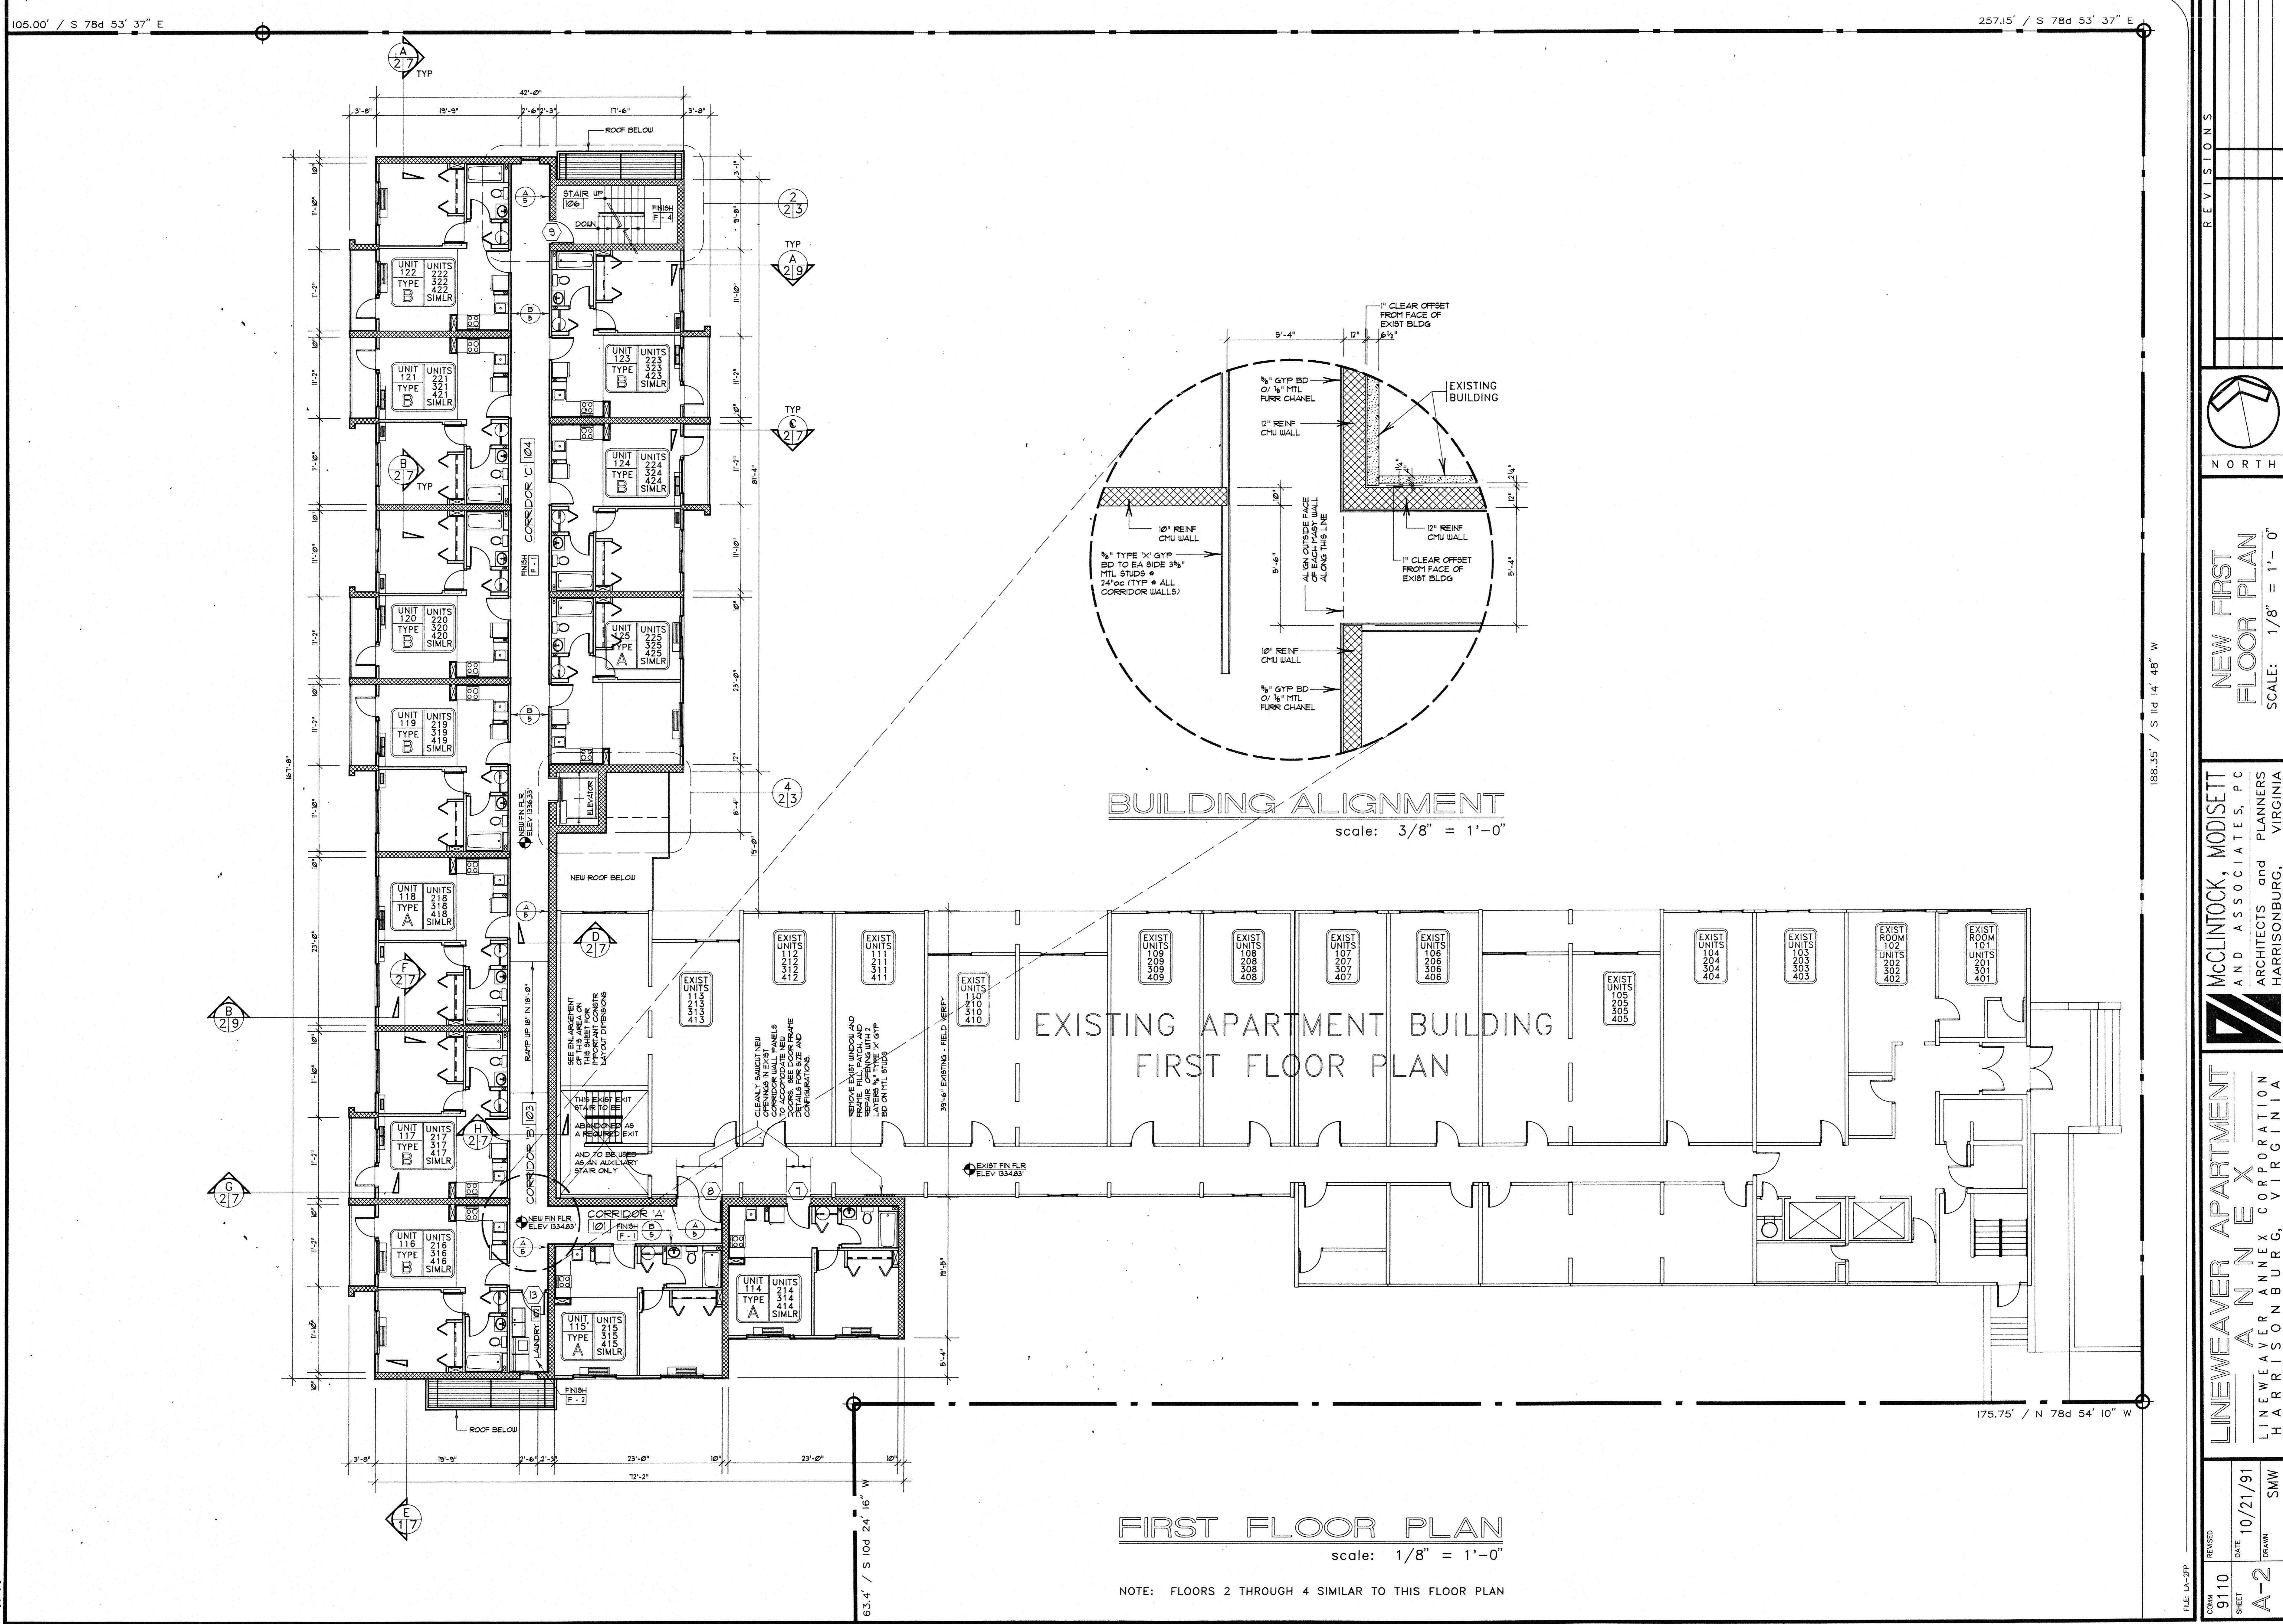

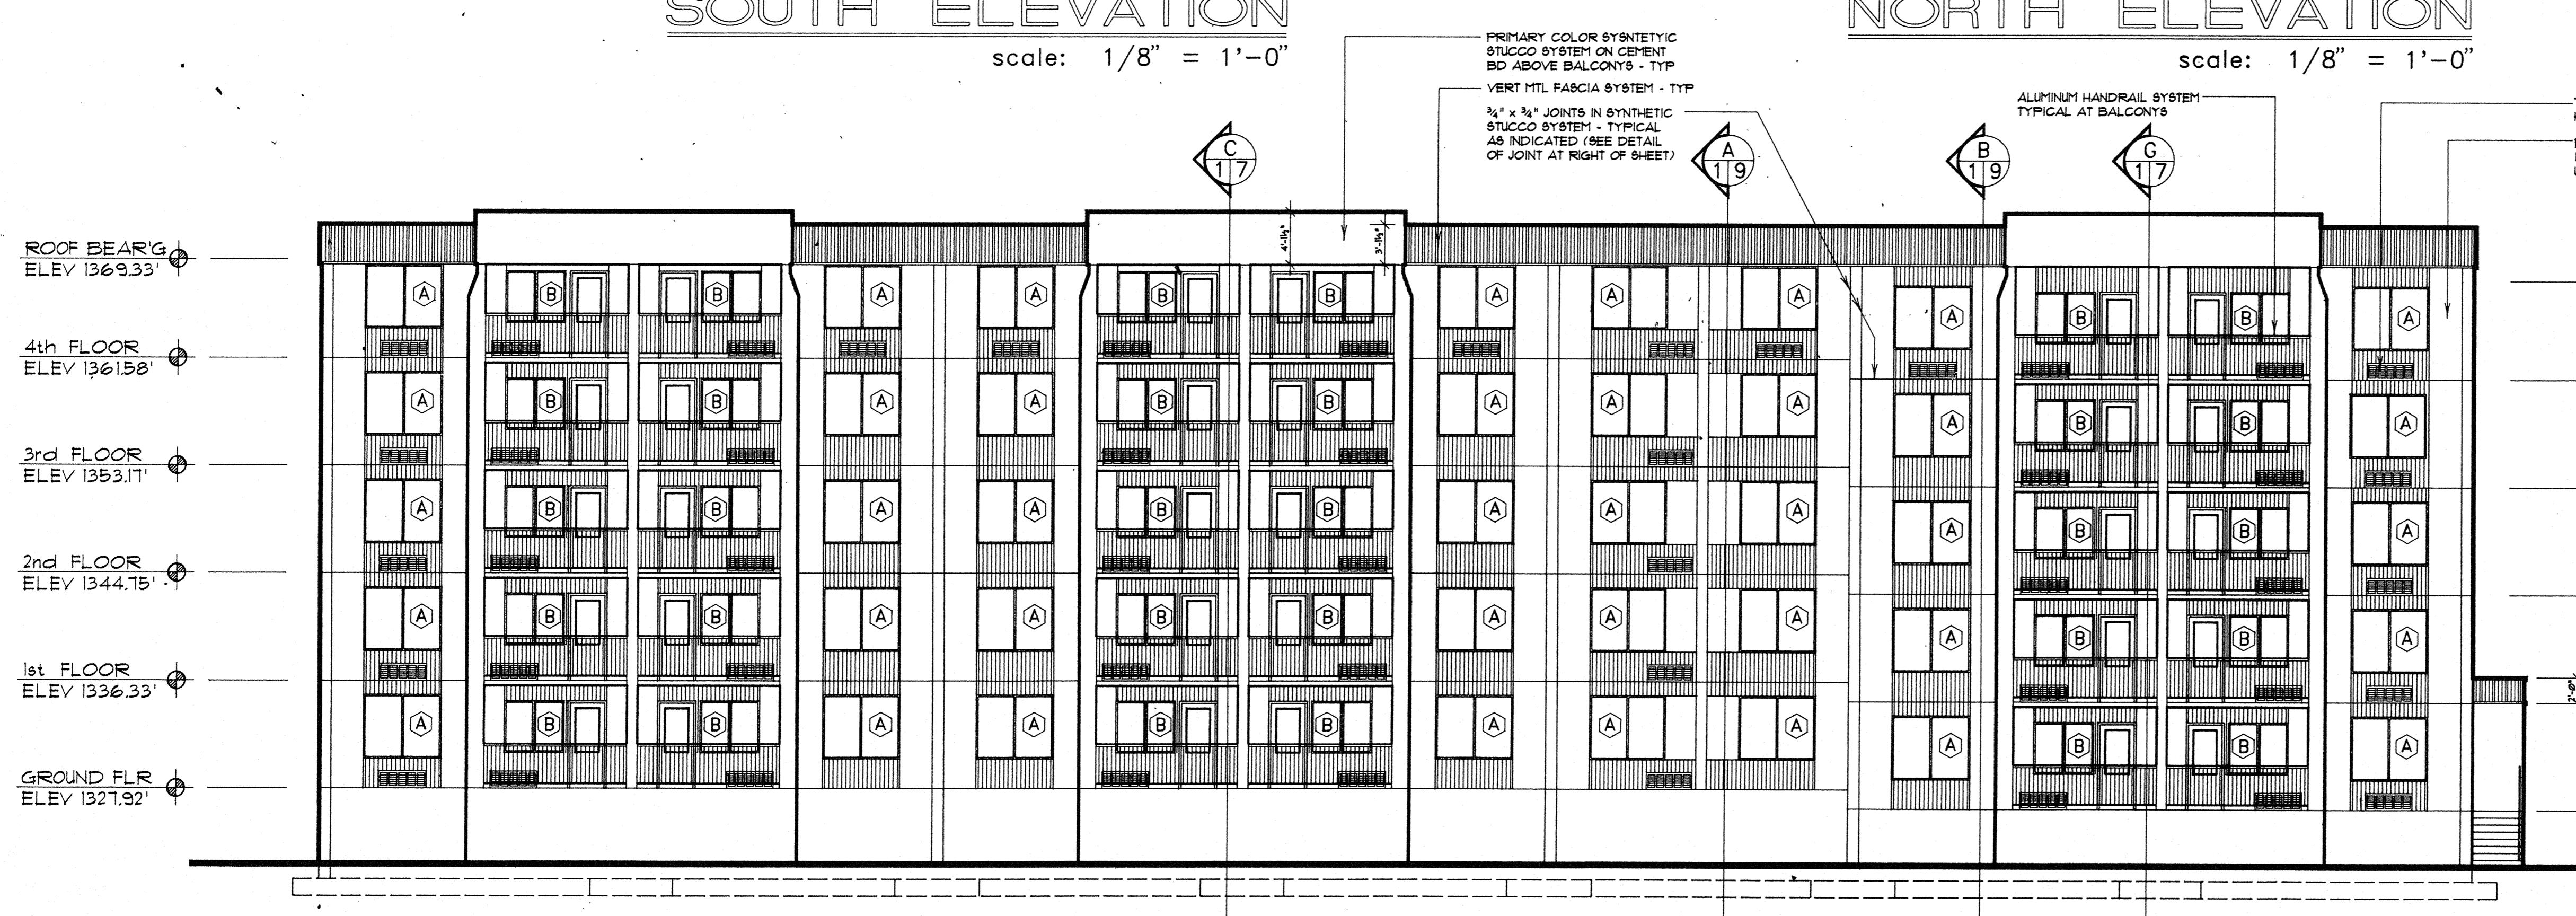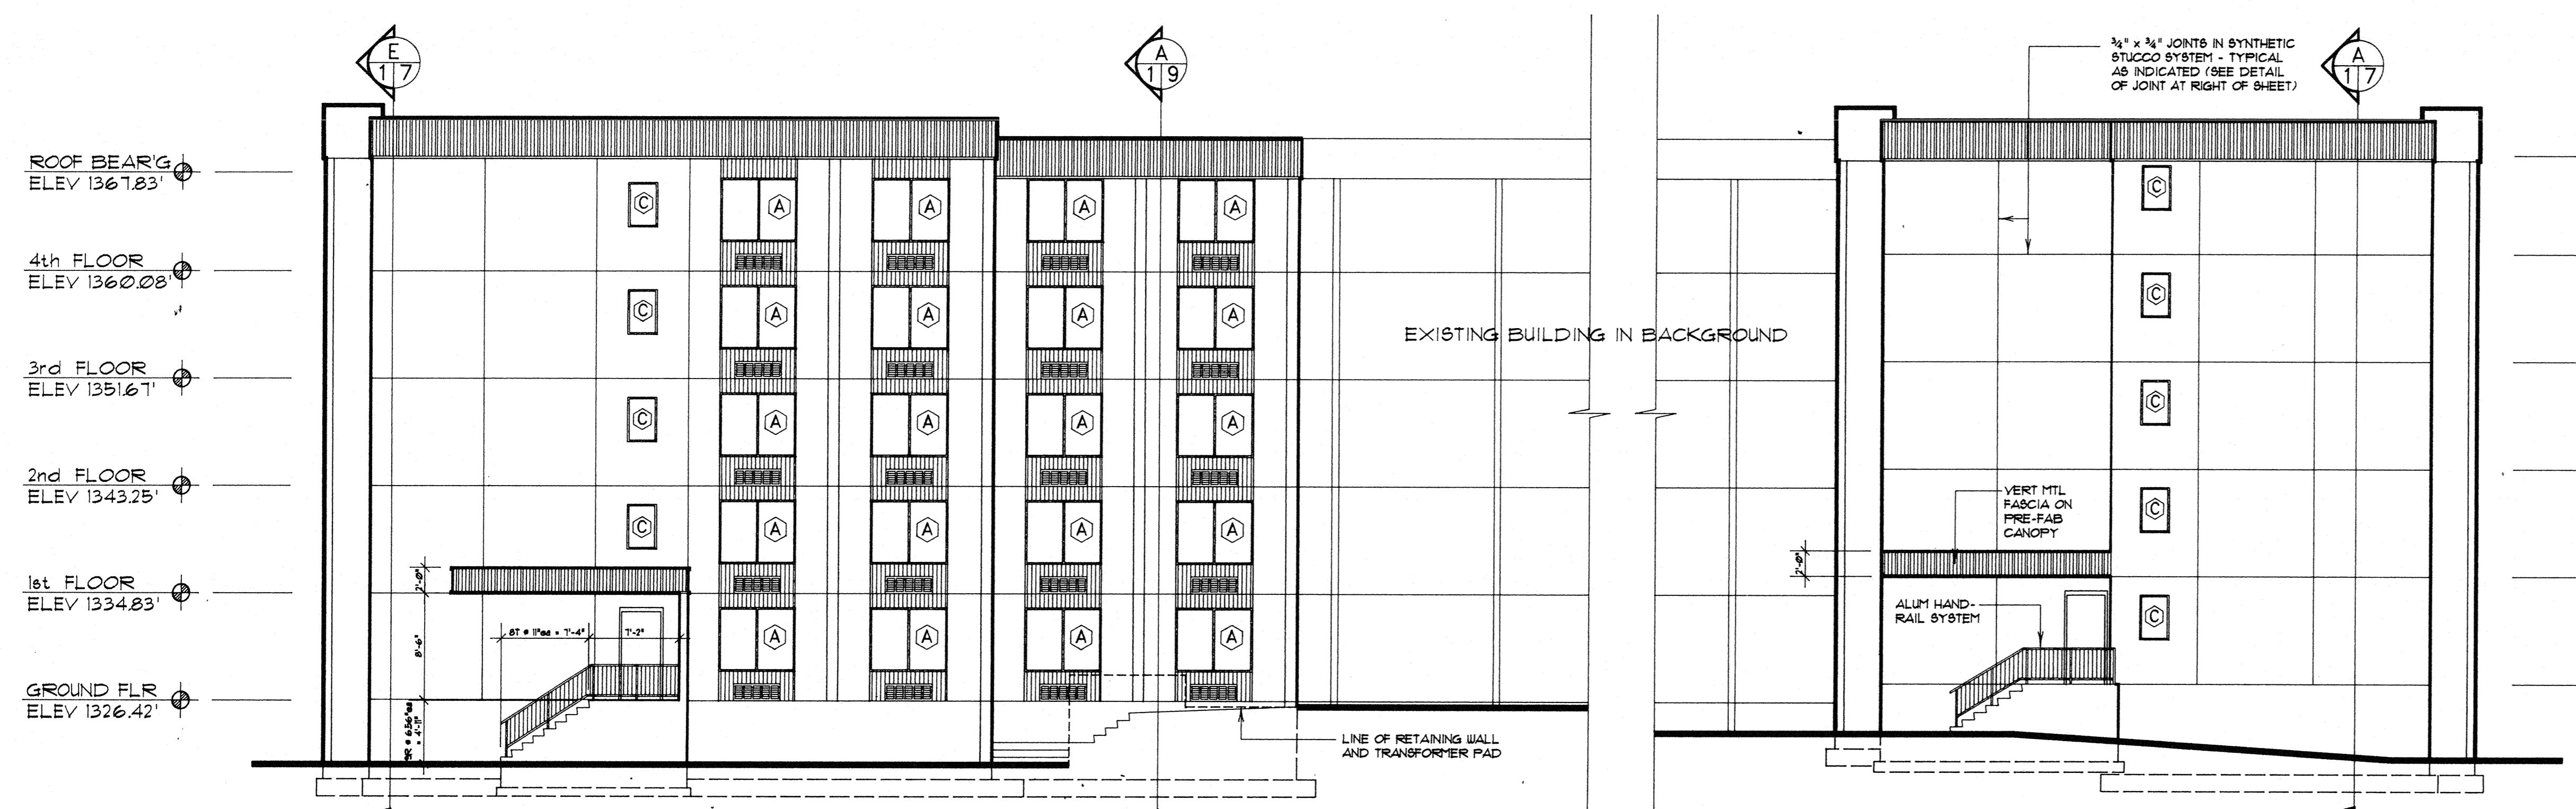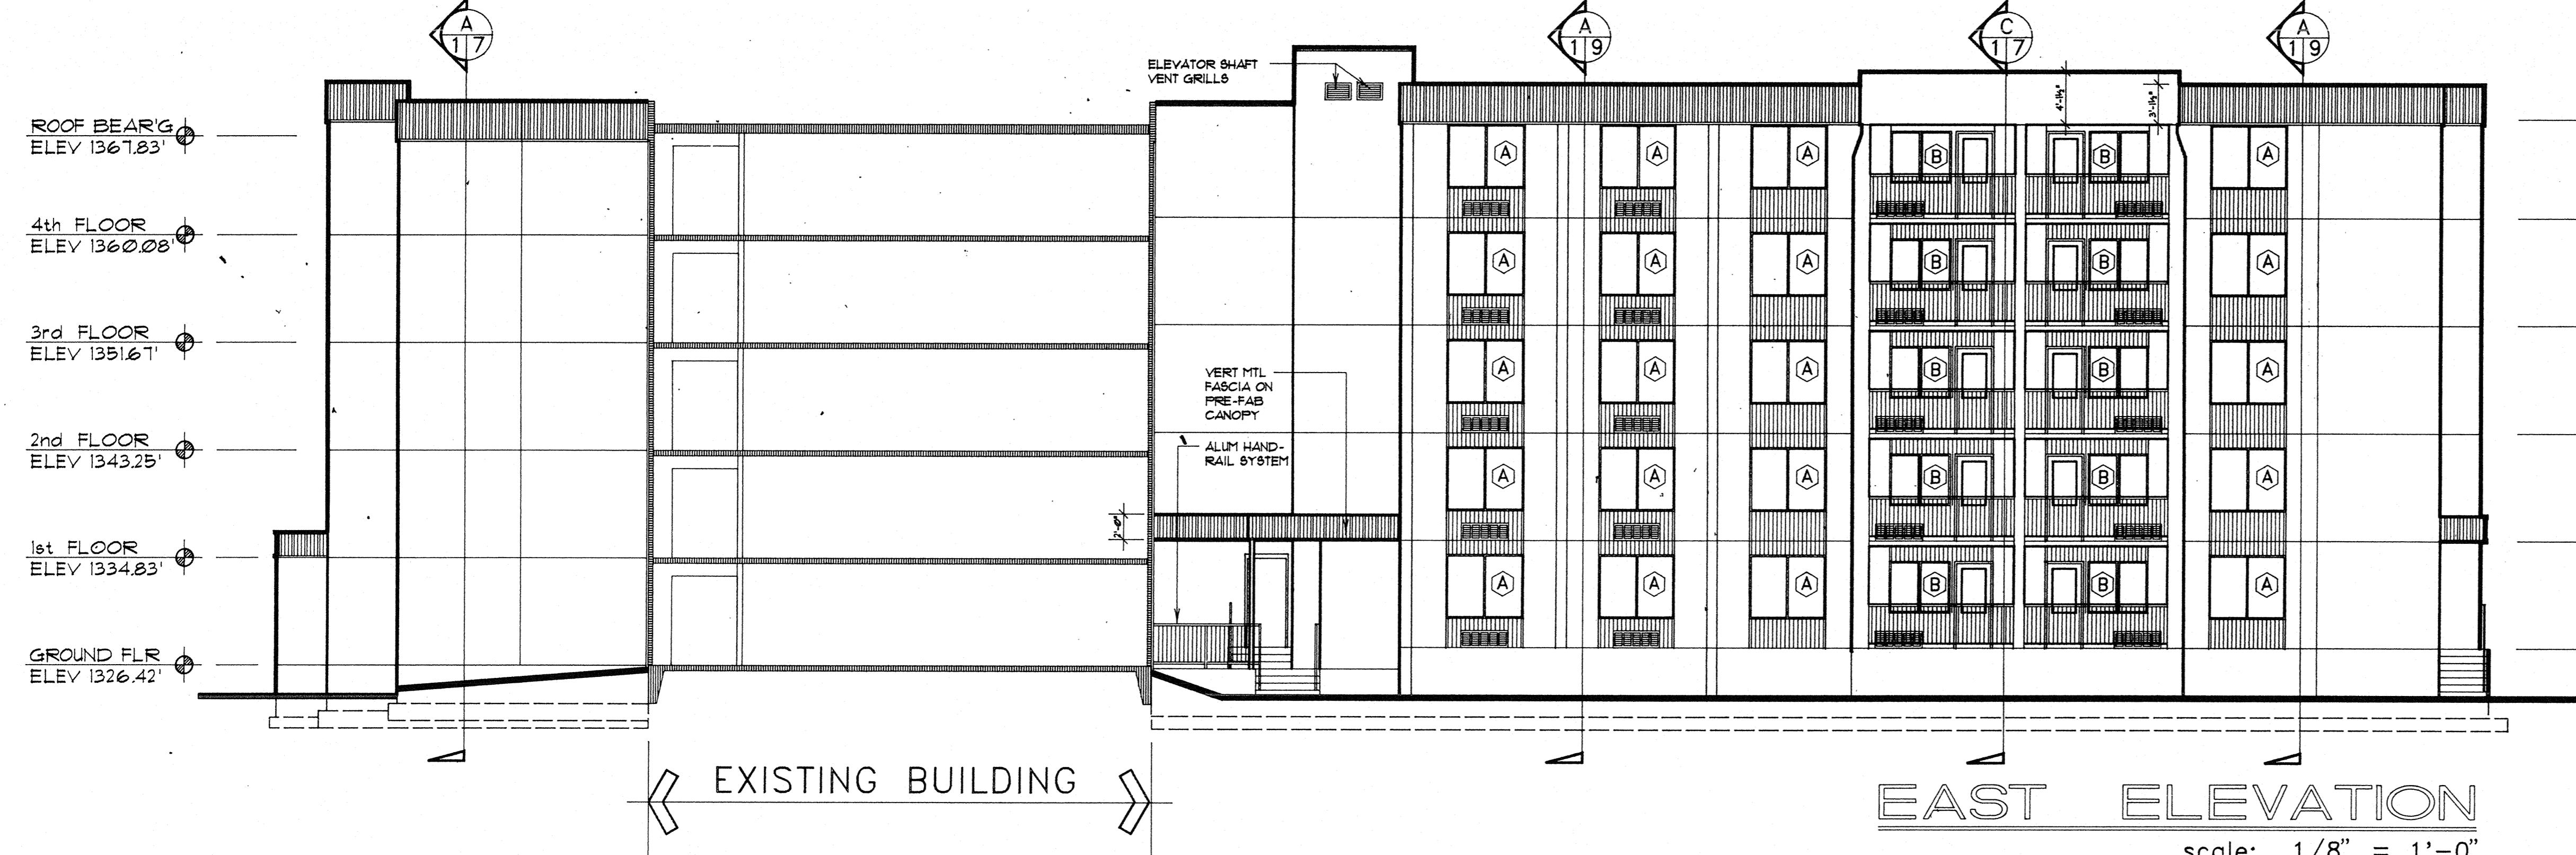

REVISIONS	
NORTH	
	EXTERIOR ELEVATIONS
	McCLINTOCK, MODSETT AND ASSOCIATES, PC ARCHITECTS and PLANNERS HARRISONBURG, VIRGINIA
	SCALE: 1/8" = 1'- 0"
FILE LA-ELEV	
REVISED	
DATE 10/21/91	
DRAWN SMW	
COMB	
SHEET A-4	
FILE LA-ELEV	

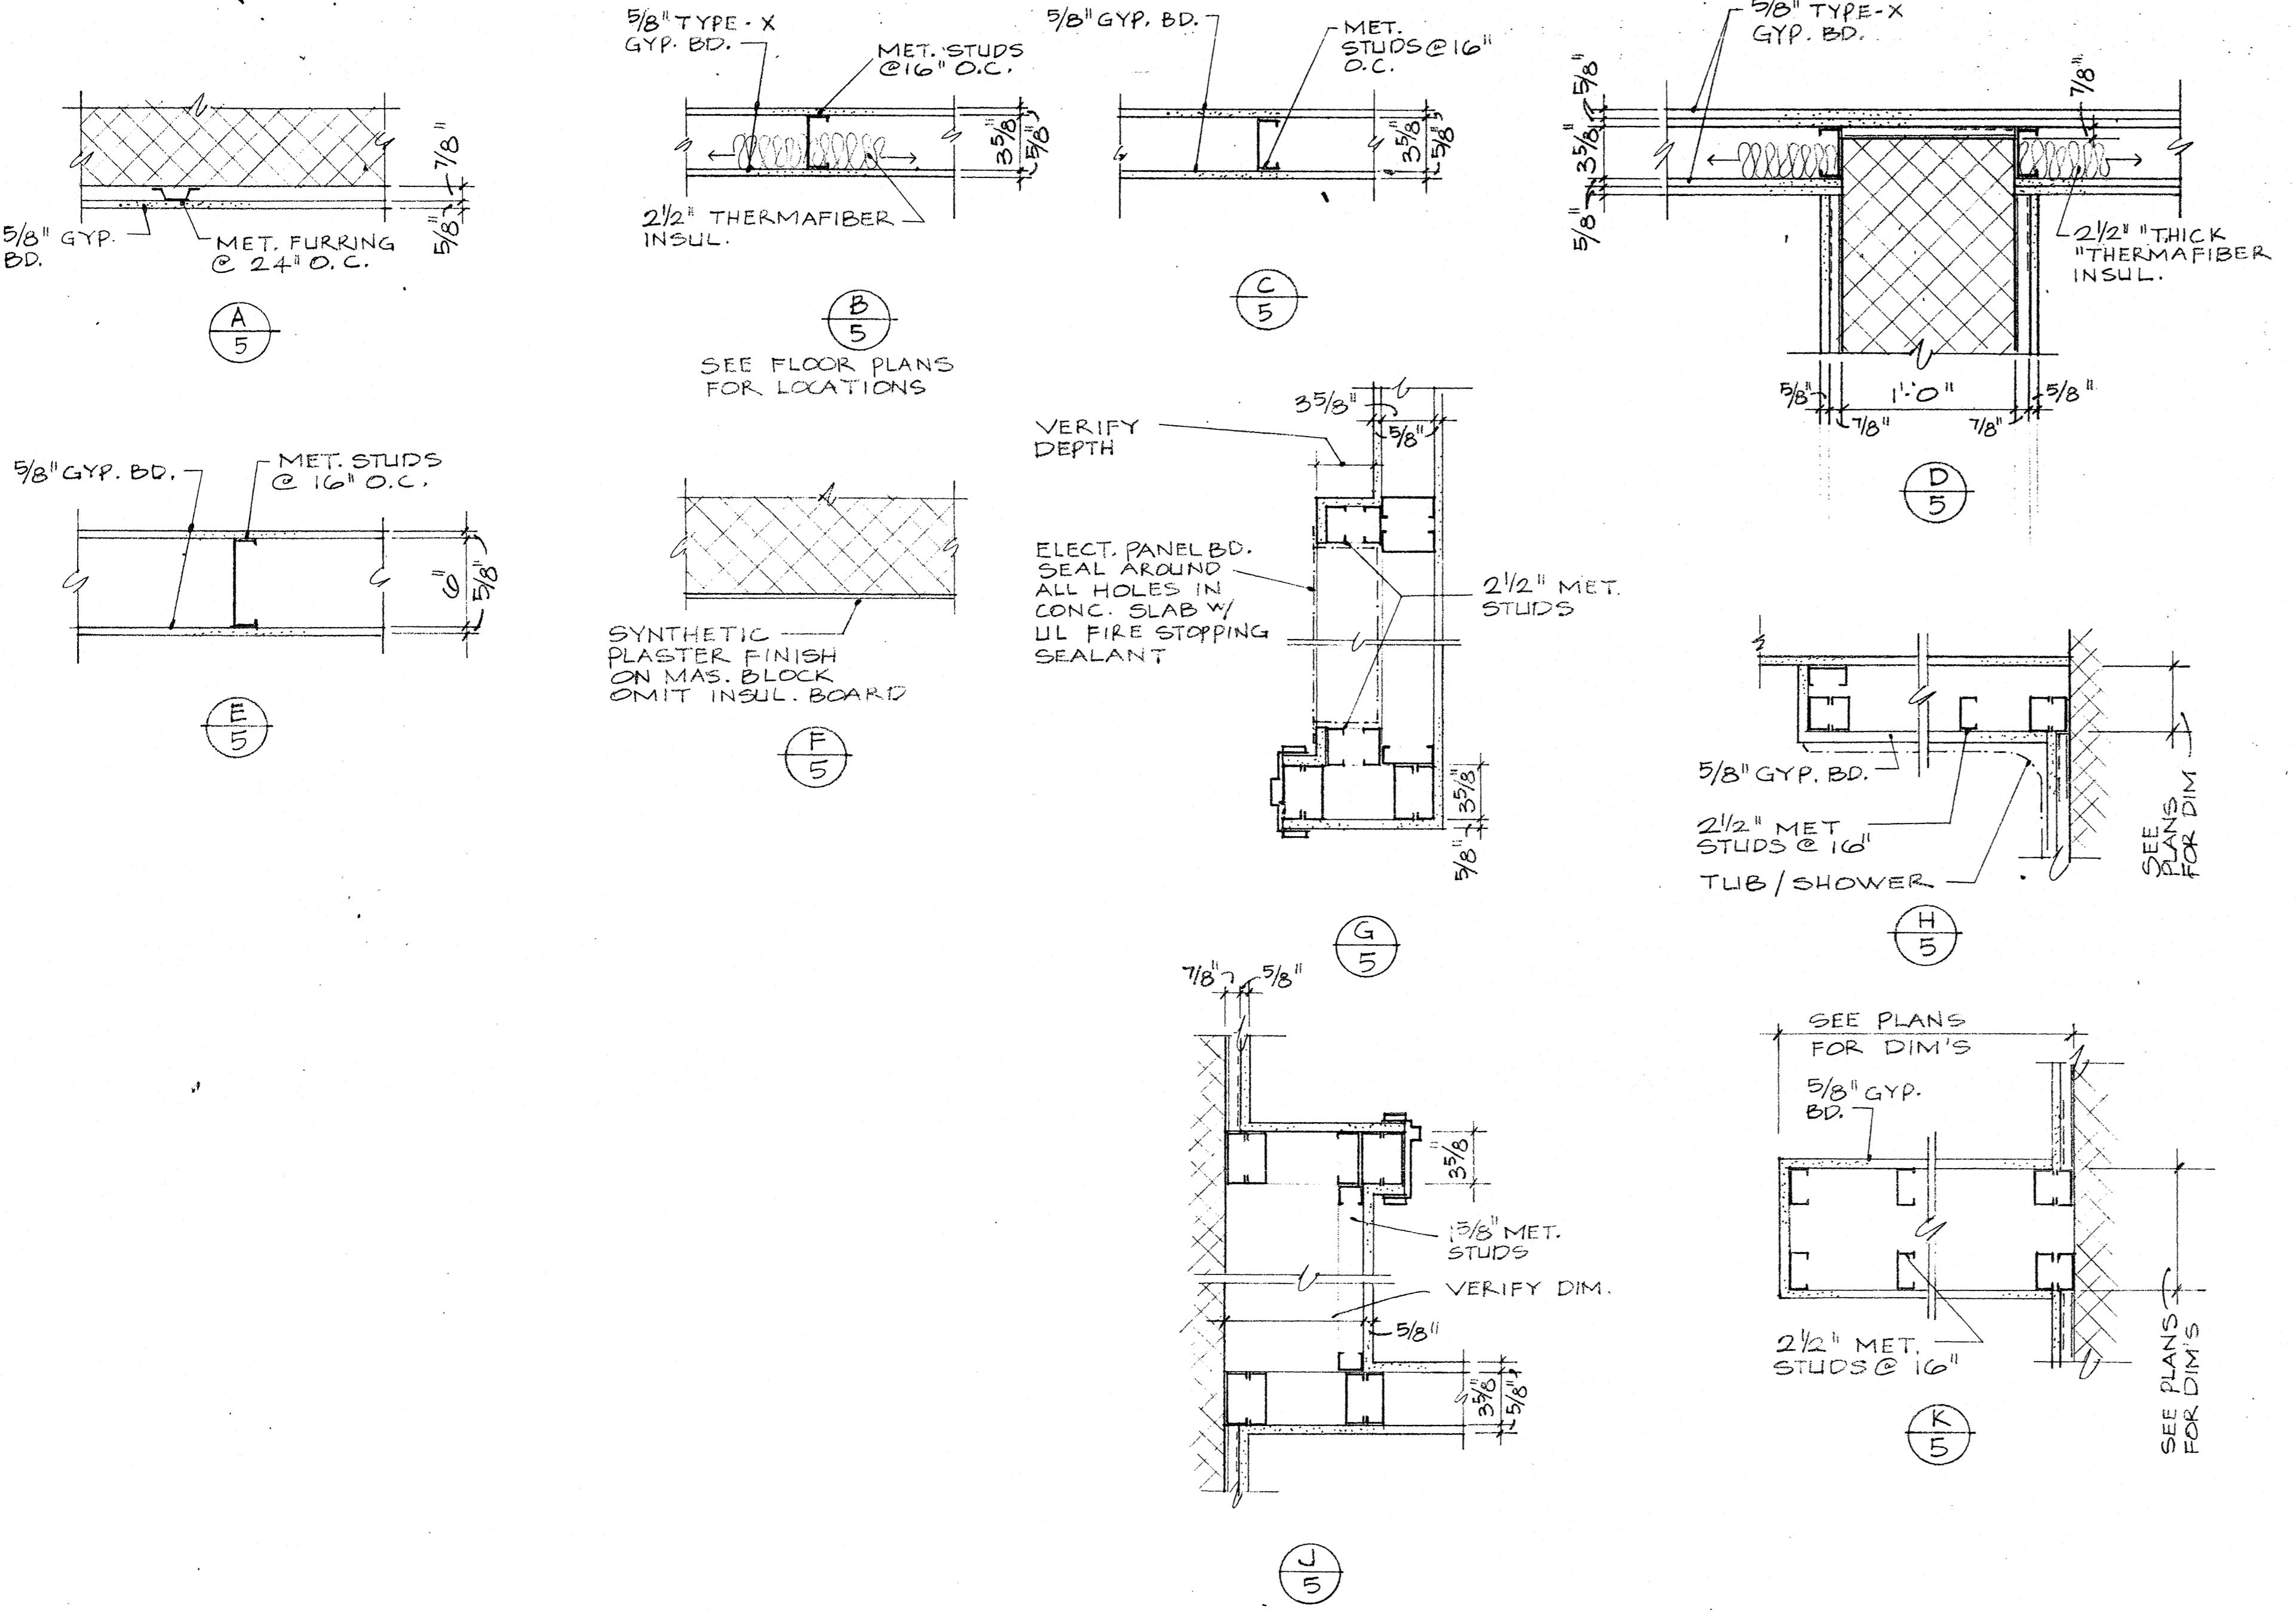

PARTITION DETAILS
(REFER TO DRAWING A-3)


MASTER INTERIOR FINISH SCHEDULE

FINISH NUMBER	FLOOR	BASE	WALLS	CEILING	LOCATION AND REMARKS
		FINISHES IN FLOOR PLANS	UNITS A & B	REFER TO $\frac{1}{4}$ " SCALE	
F-1	RVT	VBC	EPX GB	STFC	IN CORRIDORS CONTINUOUS HANDRAIL IN ALL CORRIDORS
F-2	SV	VBC	EPX GB	STFC	IN LAUNDRY ROOM
F-3	SV	VBC	EPX GB & MB	STFC	IN TRASH ROOMS
F-4	CONC	—	MB	CONC	IN STAIR STEEL PAINT ALL EXPOSED
F-5	CONC	—	MB	CONC	IN ELEV. EQUIP. R.M., MECH./ELECT. RM., GEN. & COMPACT. RM'S.


McCLINTOCK, MODISETT
AND ASSOCIATES, PC
ARCHITECTS and PLANNERS
HARRISONBURG, VIRGINIA

PROPOSED ADDITIONS & ALTERATIONS TO
LINNEWAVER APARTMENTS
LINNEWAVER ANNEX CORPORATION
HARRISONBURG, VIRGINIA

COM 9036 REV'D 10-21-91
SHEET A-5 DRAWN C.E. WILHELM
DATE 4-29-91
No. 1229
ARCHITECT

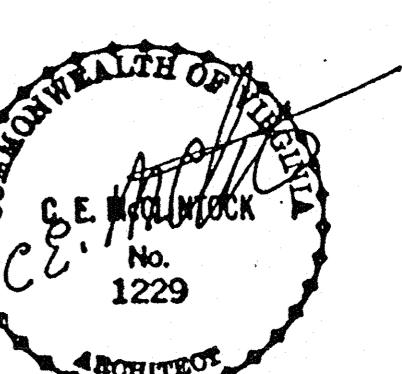


REVISIONS	
○	NORTH

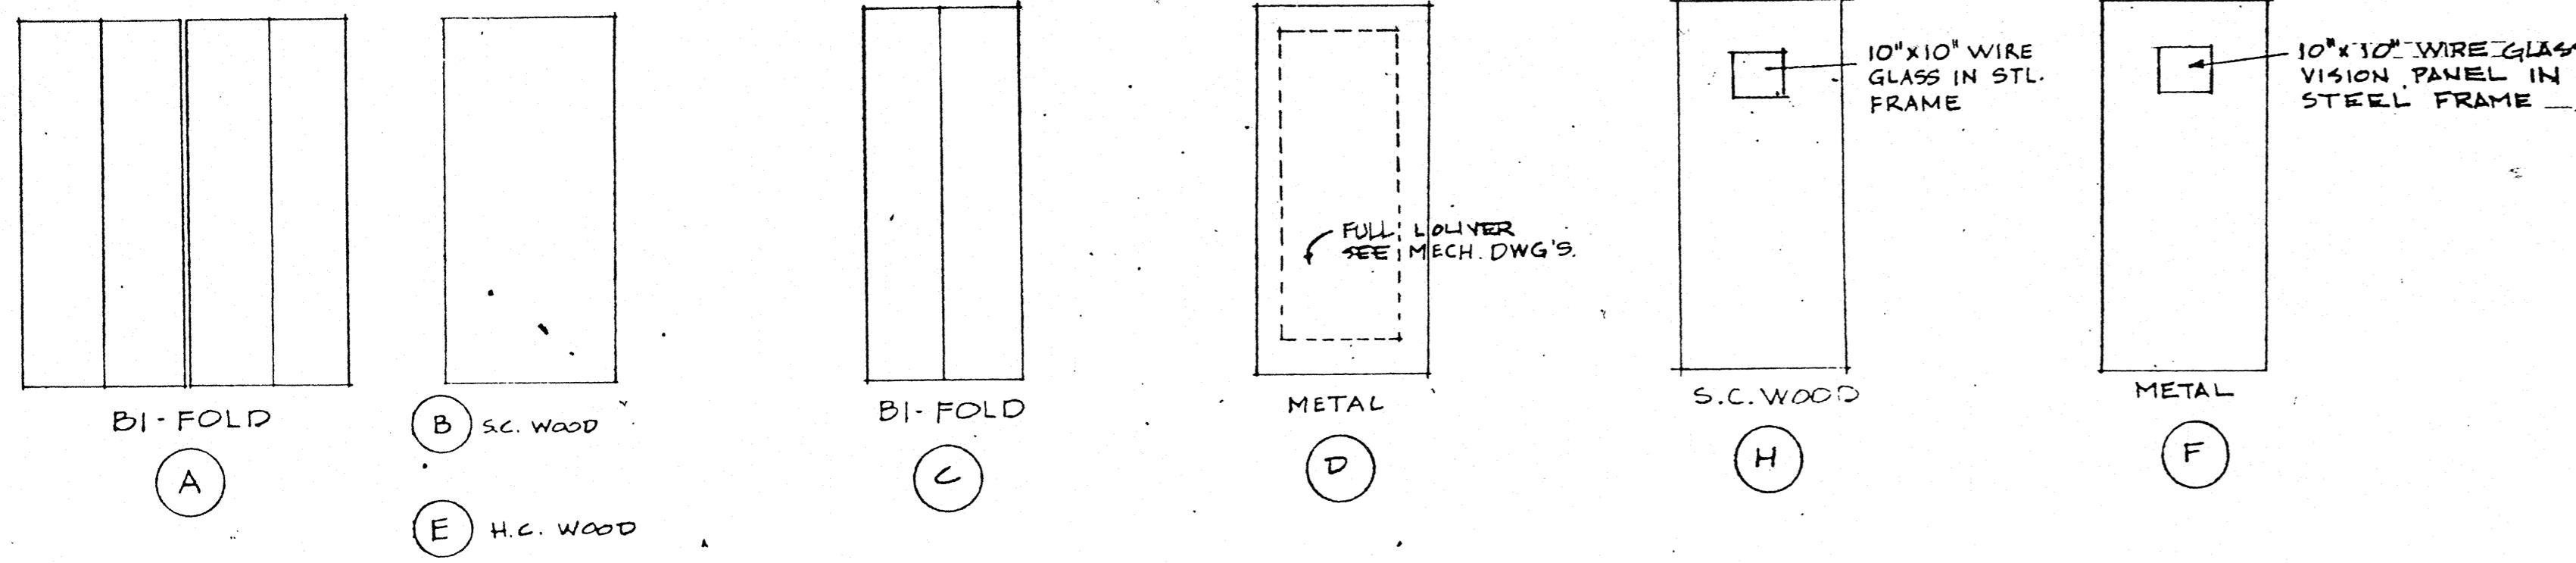


DOOR TYPES


3/8" = 1'-0"

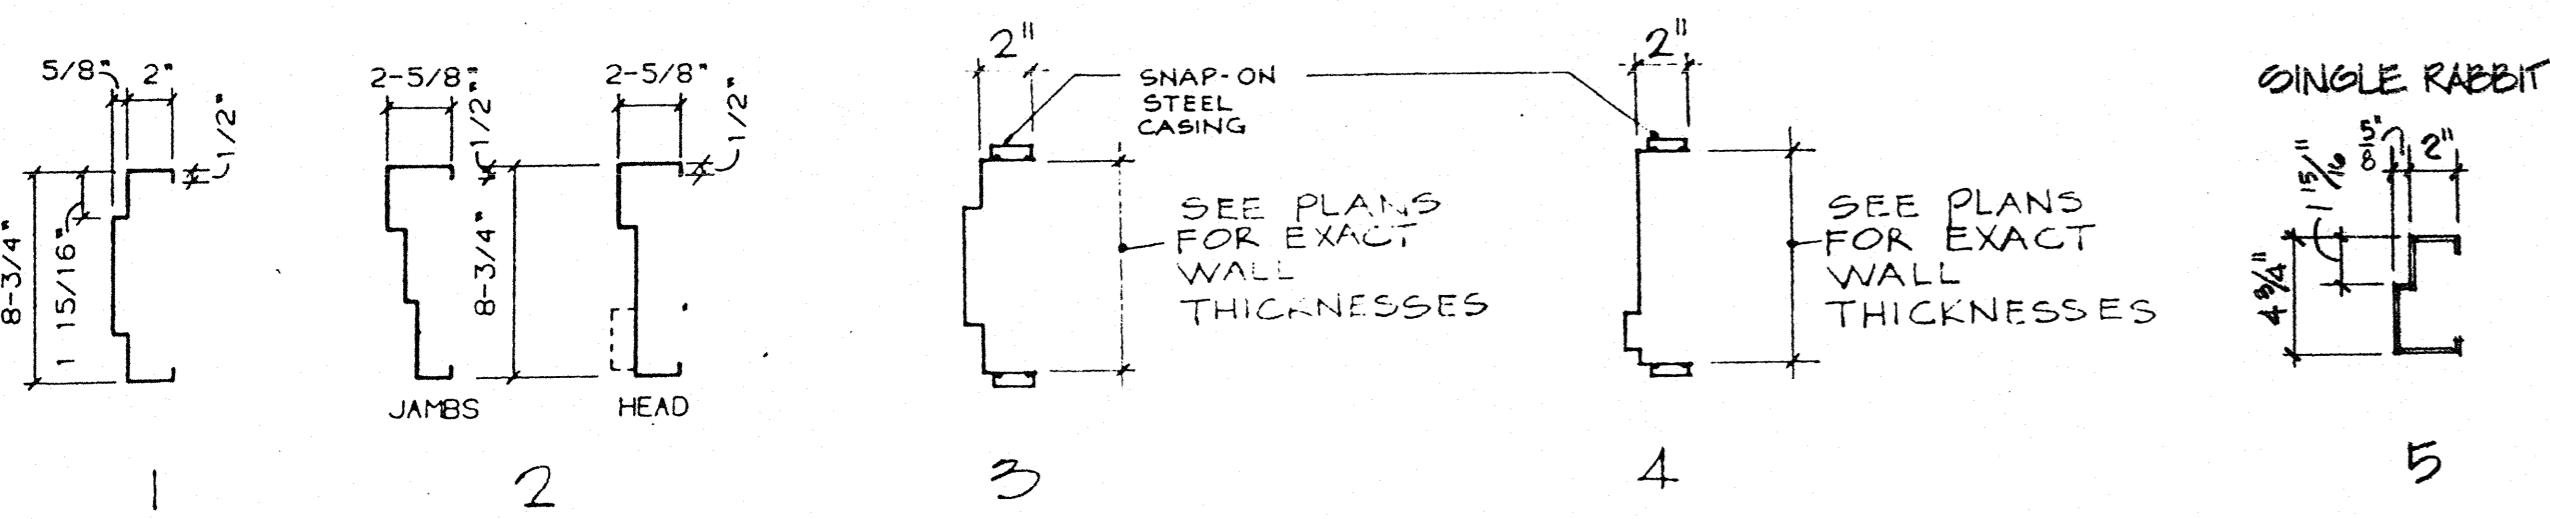

DOOR FRAME TYPES

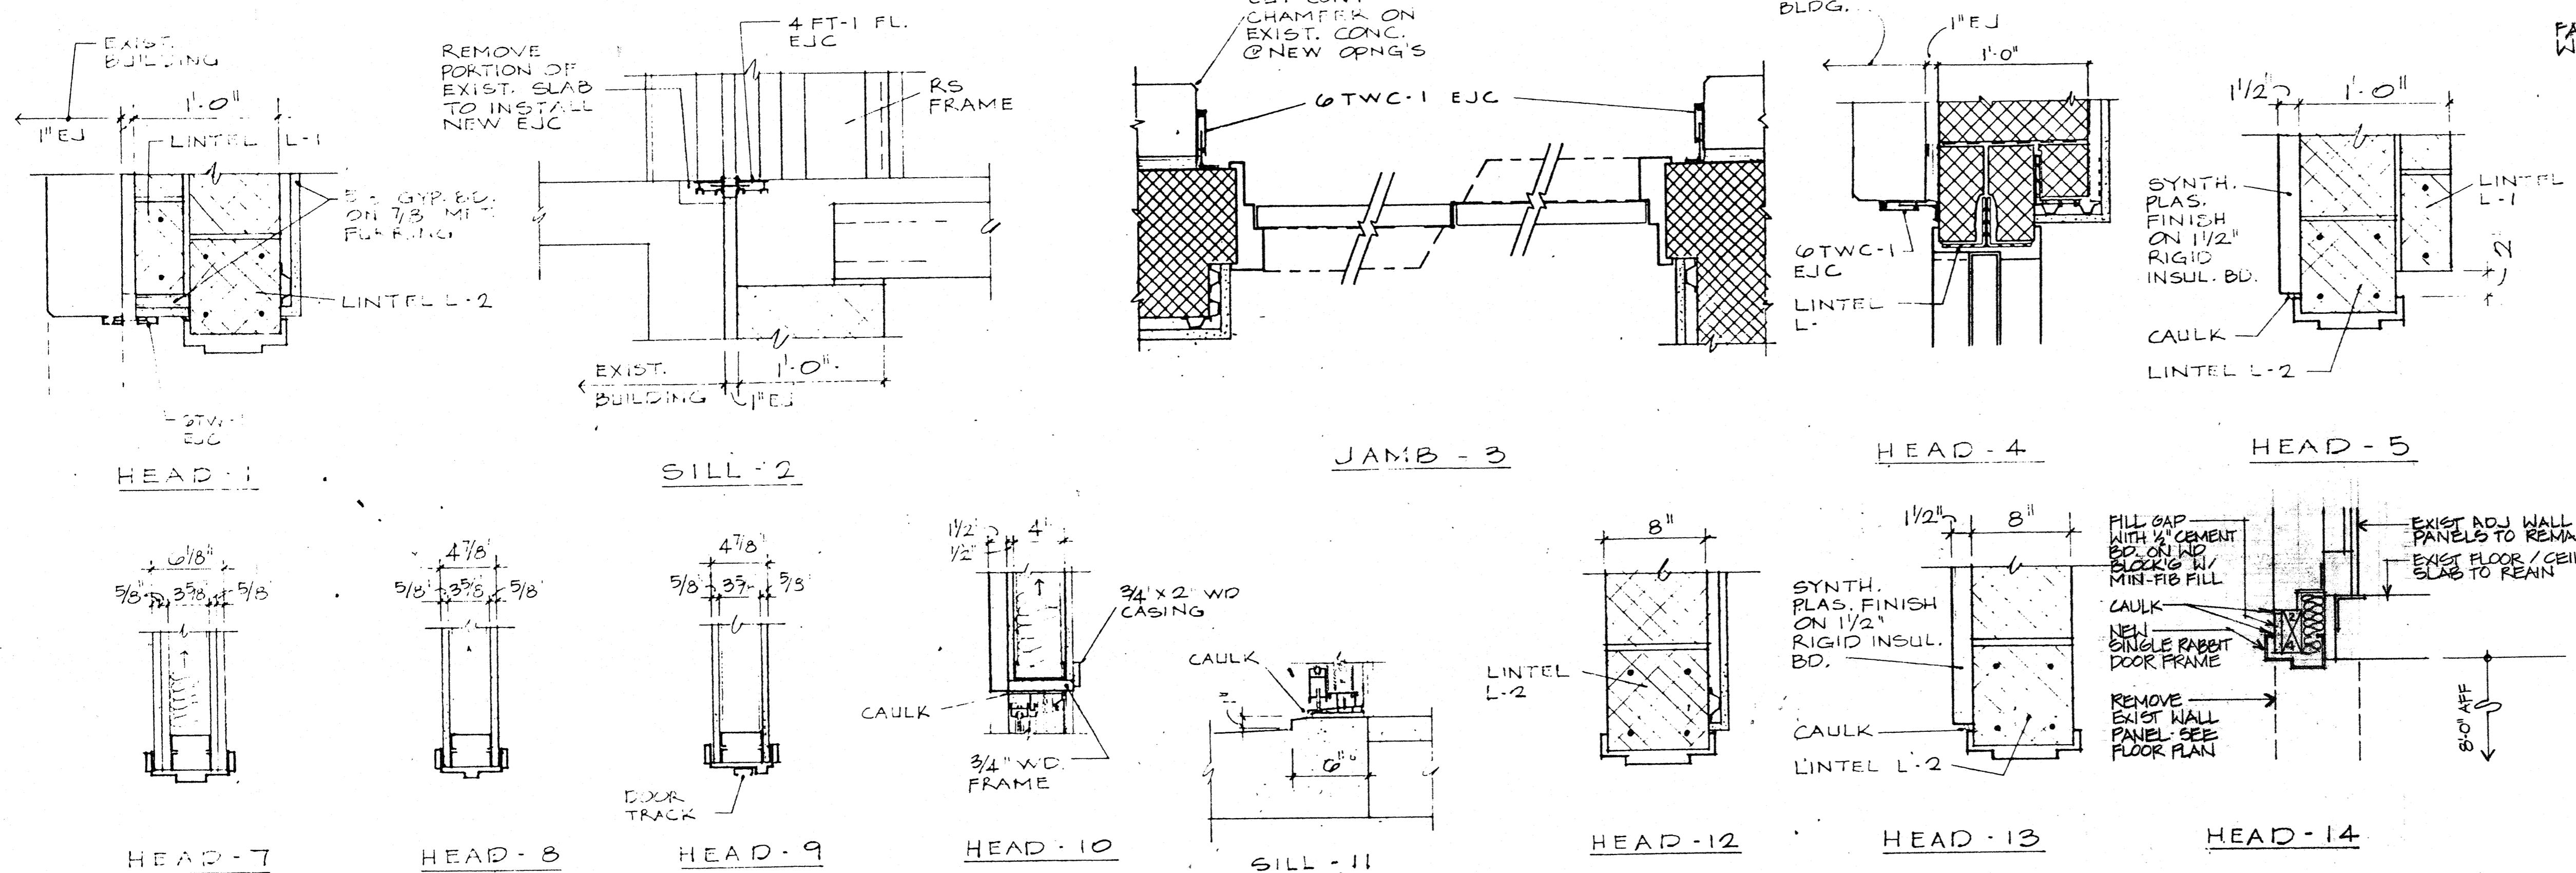

DOOR FRAME DETAILS

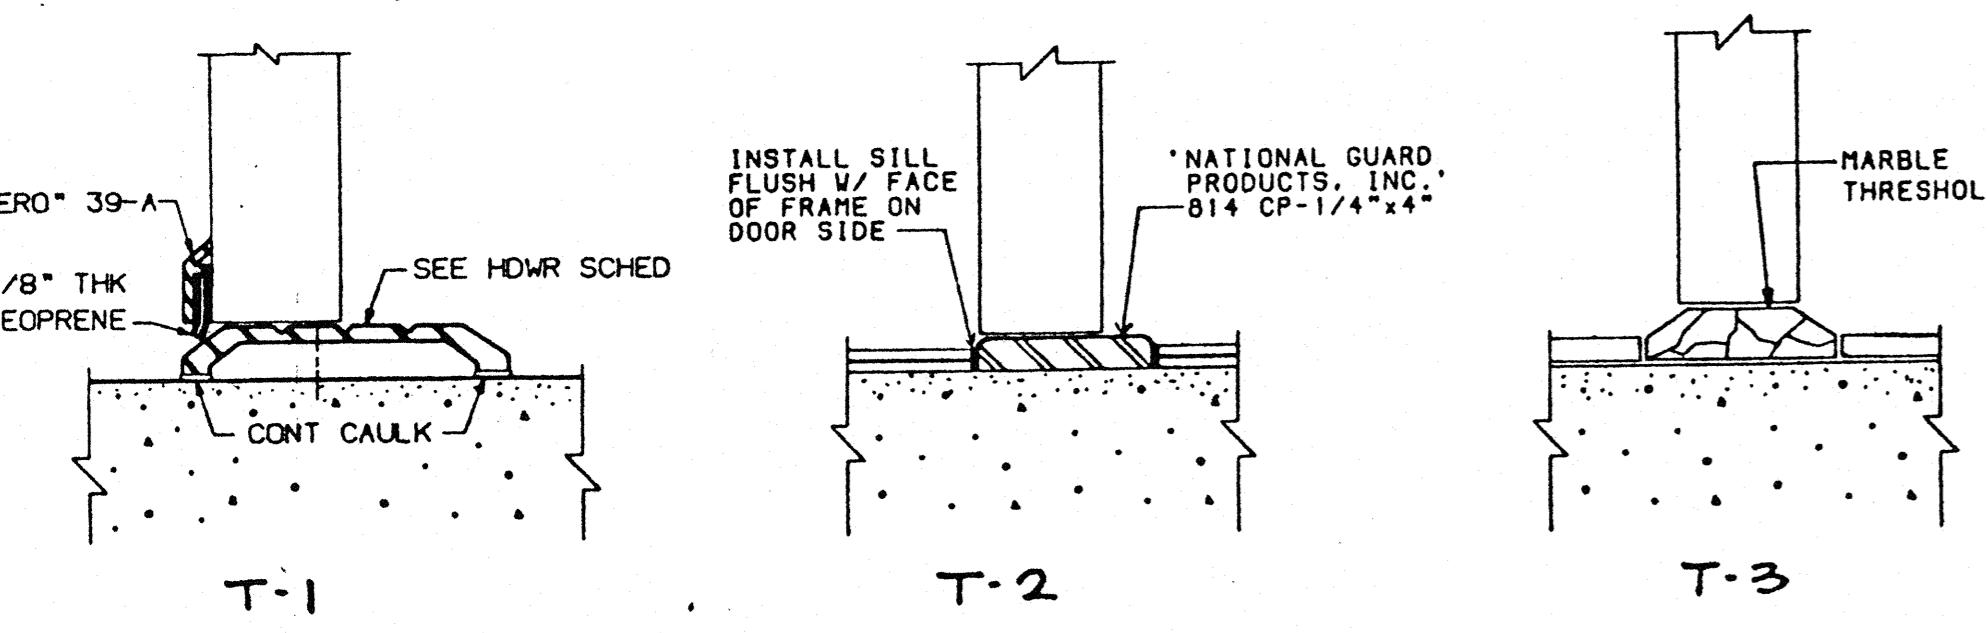

THRESHOLD TYPES

MASTER DOOR SCHEDULE

DOOR NO.	LOCATION	DOOR TYPE	DOOR MATERIAL	SIZE			FRAME TYPE	FRAME MATERIAL	FRAME DETAIL	HARDWARE NO.	REMARKS
				W	H	T					
1											
2											
3											
4											
5											
6											
7	HALL INTO UNIT	B	SC WD	3'-0"	6'-8"	13/4"	I	RS	1,2		20 MIN. LABEL THRES. T-
8	CORRIDOR 'A'	(2)H	SC WD	3'-0"	6'-8"	13/4"	2	RS	2,3,4		1 1/2 HR 'B' LABEL THRES. T-2
9	STAIR	H	SC WD	3'-0"	6'-8"	13/4"	I	RS	12		1 1/2 HR 'B' LABEL THRES. T-2
10	NOT USED										
11	CORRIDOR 'B' TO EXTERIOR	F	MET	3'-0"	6'-8"	13/4"	I	RS	5,6		THRES. T-1
12	TO EXTERIOR	F	MET	3'-0"	6'-8"	13/4"	I	RS	13,6		THRES. T-1
13	LAUNDRY	B	SC WD	3'-0"	6'-8"	13/4"	3	RS	7		
14	ELEV. EQUIP. RM.	D	MET	3'-0"	6'-8"	13/4"	I	RS	18		1 1/2 HR 'B' LABEL
15	NEW MECHANICAL ROOM	D*	MET	4'-0"	8'-0"	13/4"	5	RS	14		THRES. T-1/*NO LOWERERS REQ.

NORTH


REVISIONS


MASTER DOOR SCHEDULE & DETAILS

DOOR SCHEDULE ABBREVIATIONS
 SC = SOLID CORE
 HC = HOLLOW CORE
 MET = METAL
 ALUM = ALUMINUM
 RS = ROLLED STEEL
 WD = WOOD

PROPOSED ADDITIONS & ALTERATIONS TO:
LINeweaver Apartments
 LINEWEAVER ANNEX CORPORATION
 HARRISONBURG, VIRGINIA

CONGOWNAH OF C. E. MCLINTOCK No. 1229
 DRAWN BY C. E. MCLINTOCK
 FILE NUMBER A-6
 DATE 10-21-91
 SHEET 4-29-91








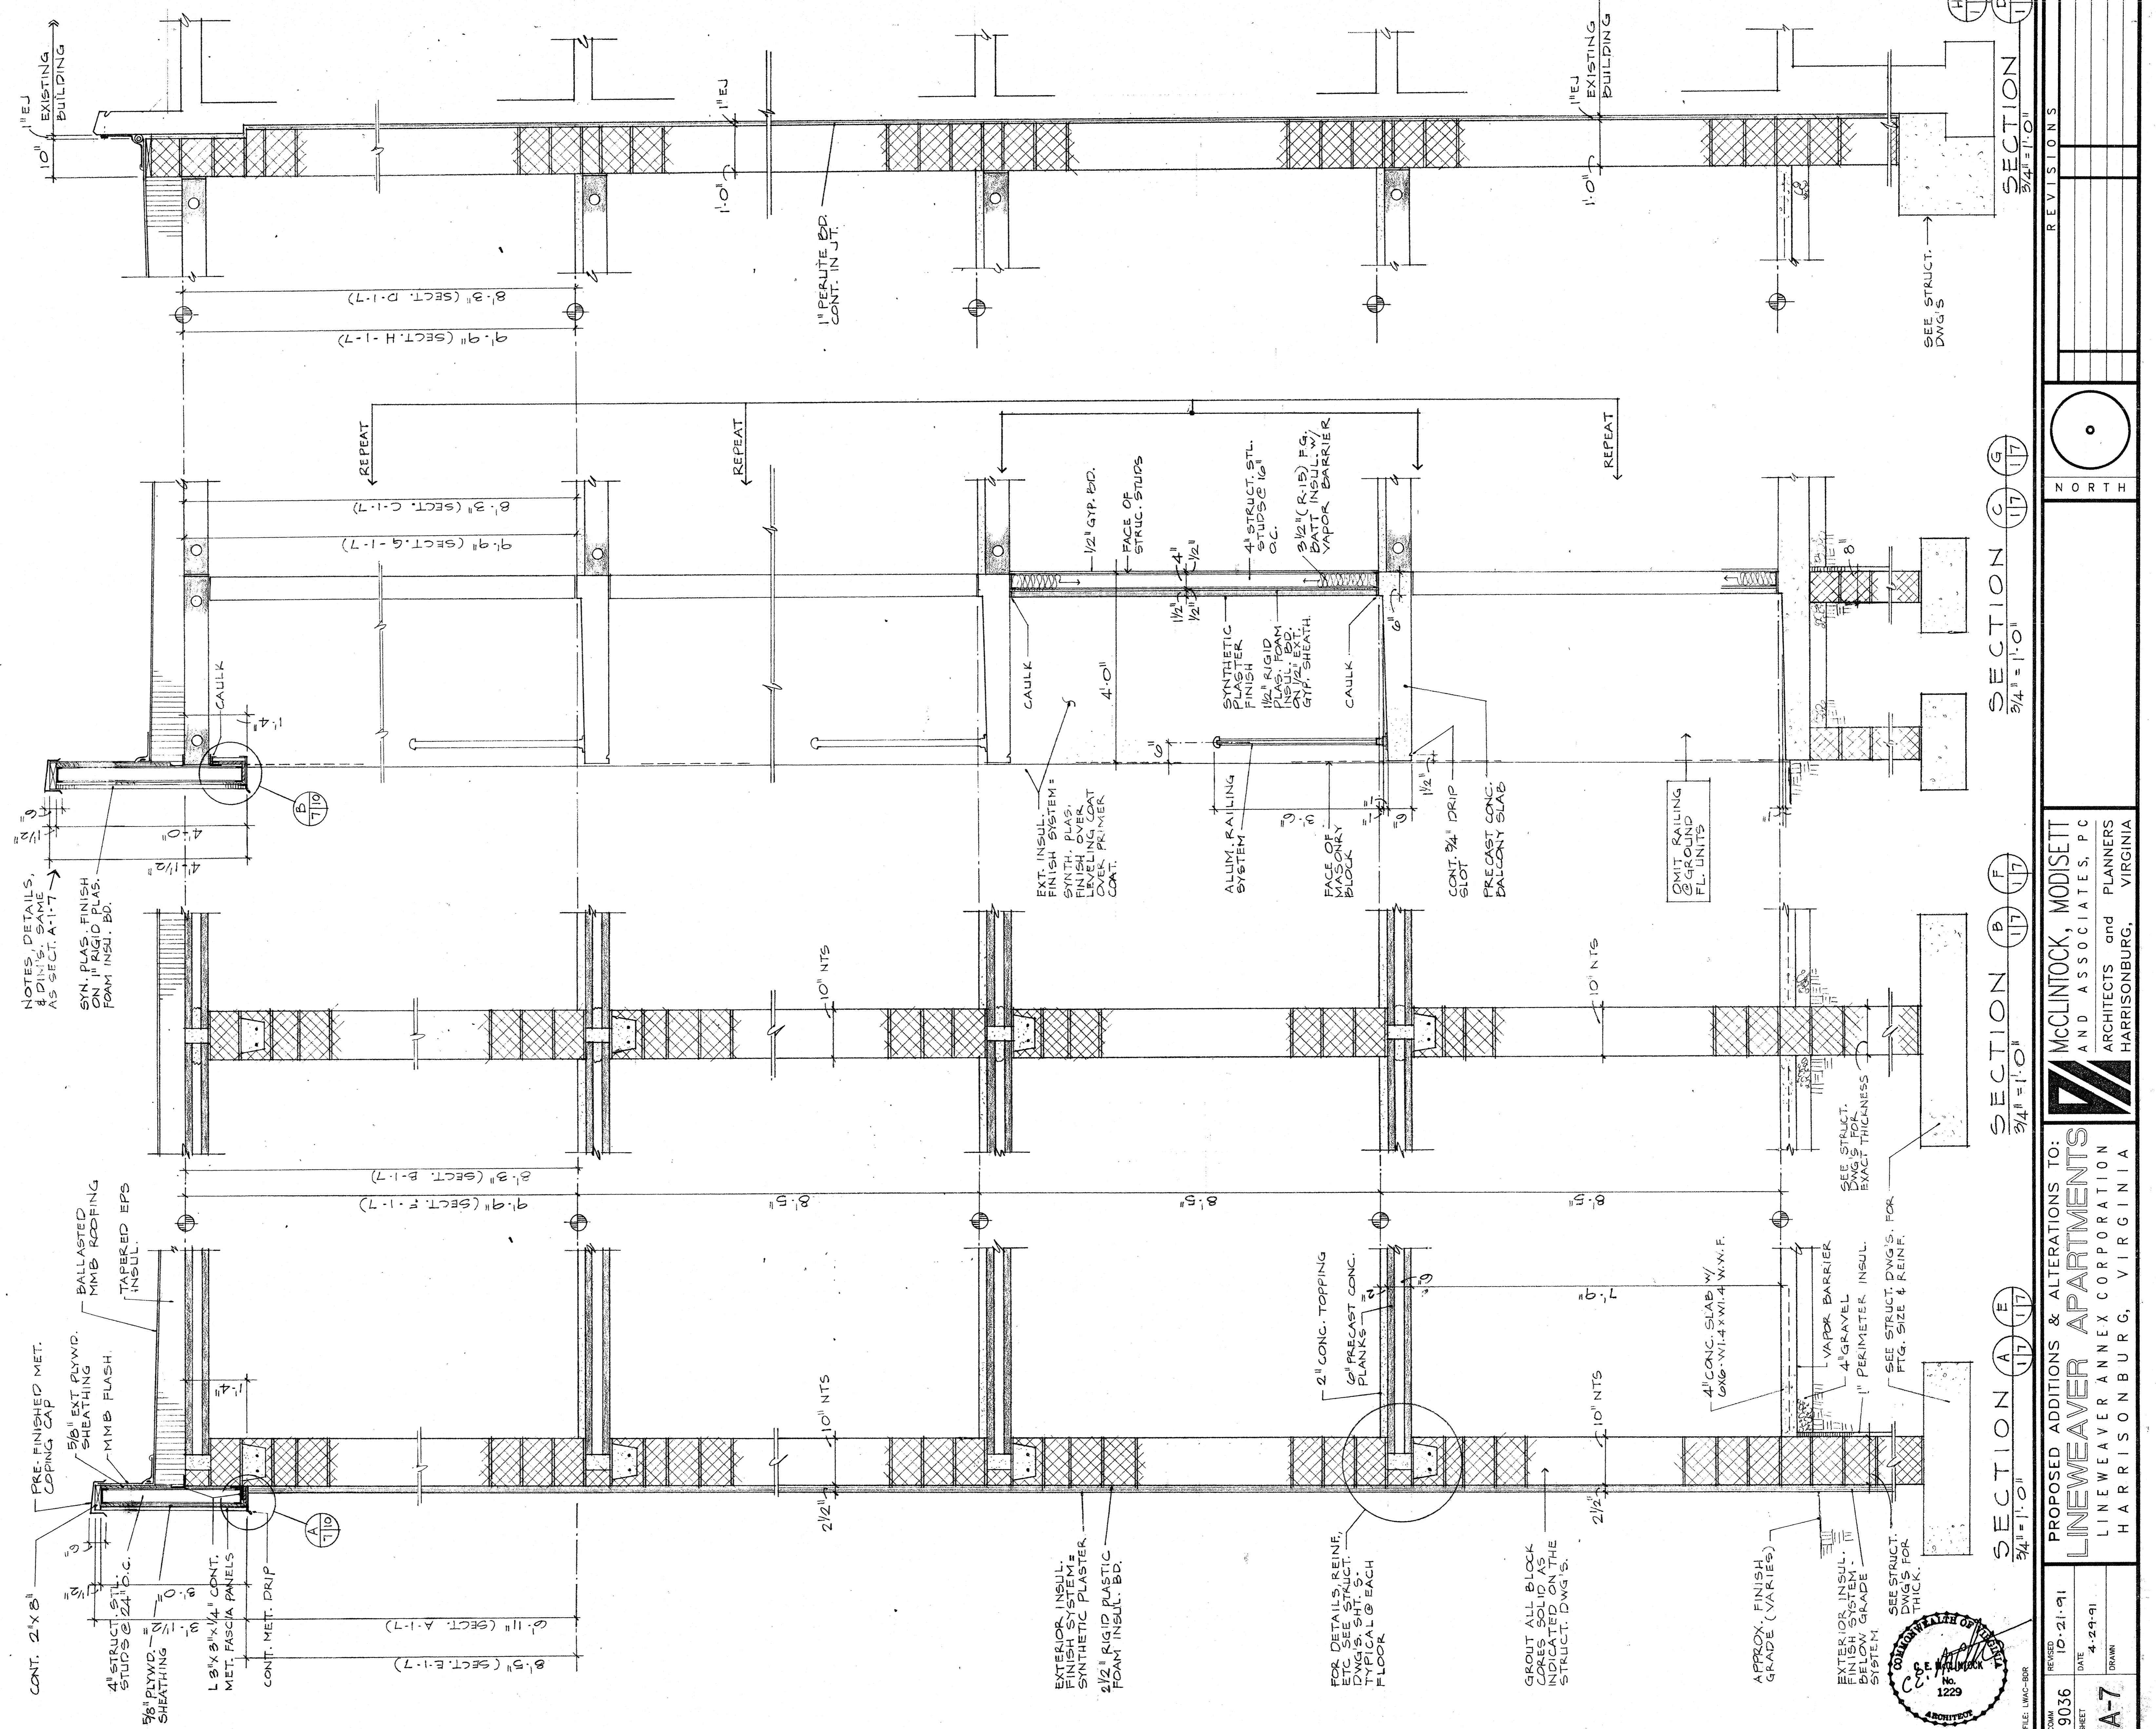


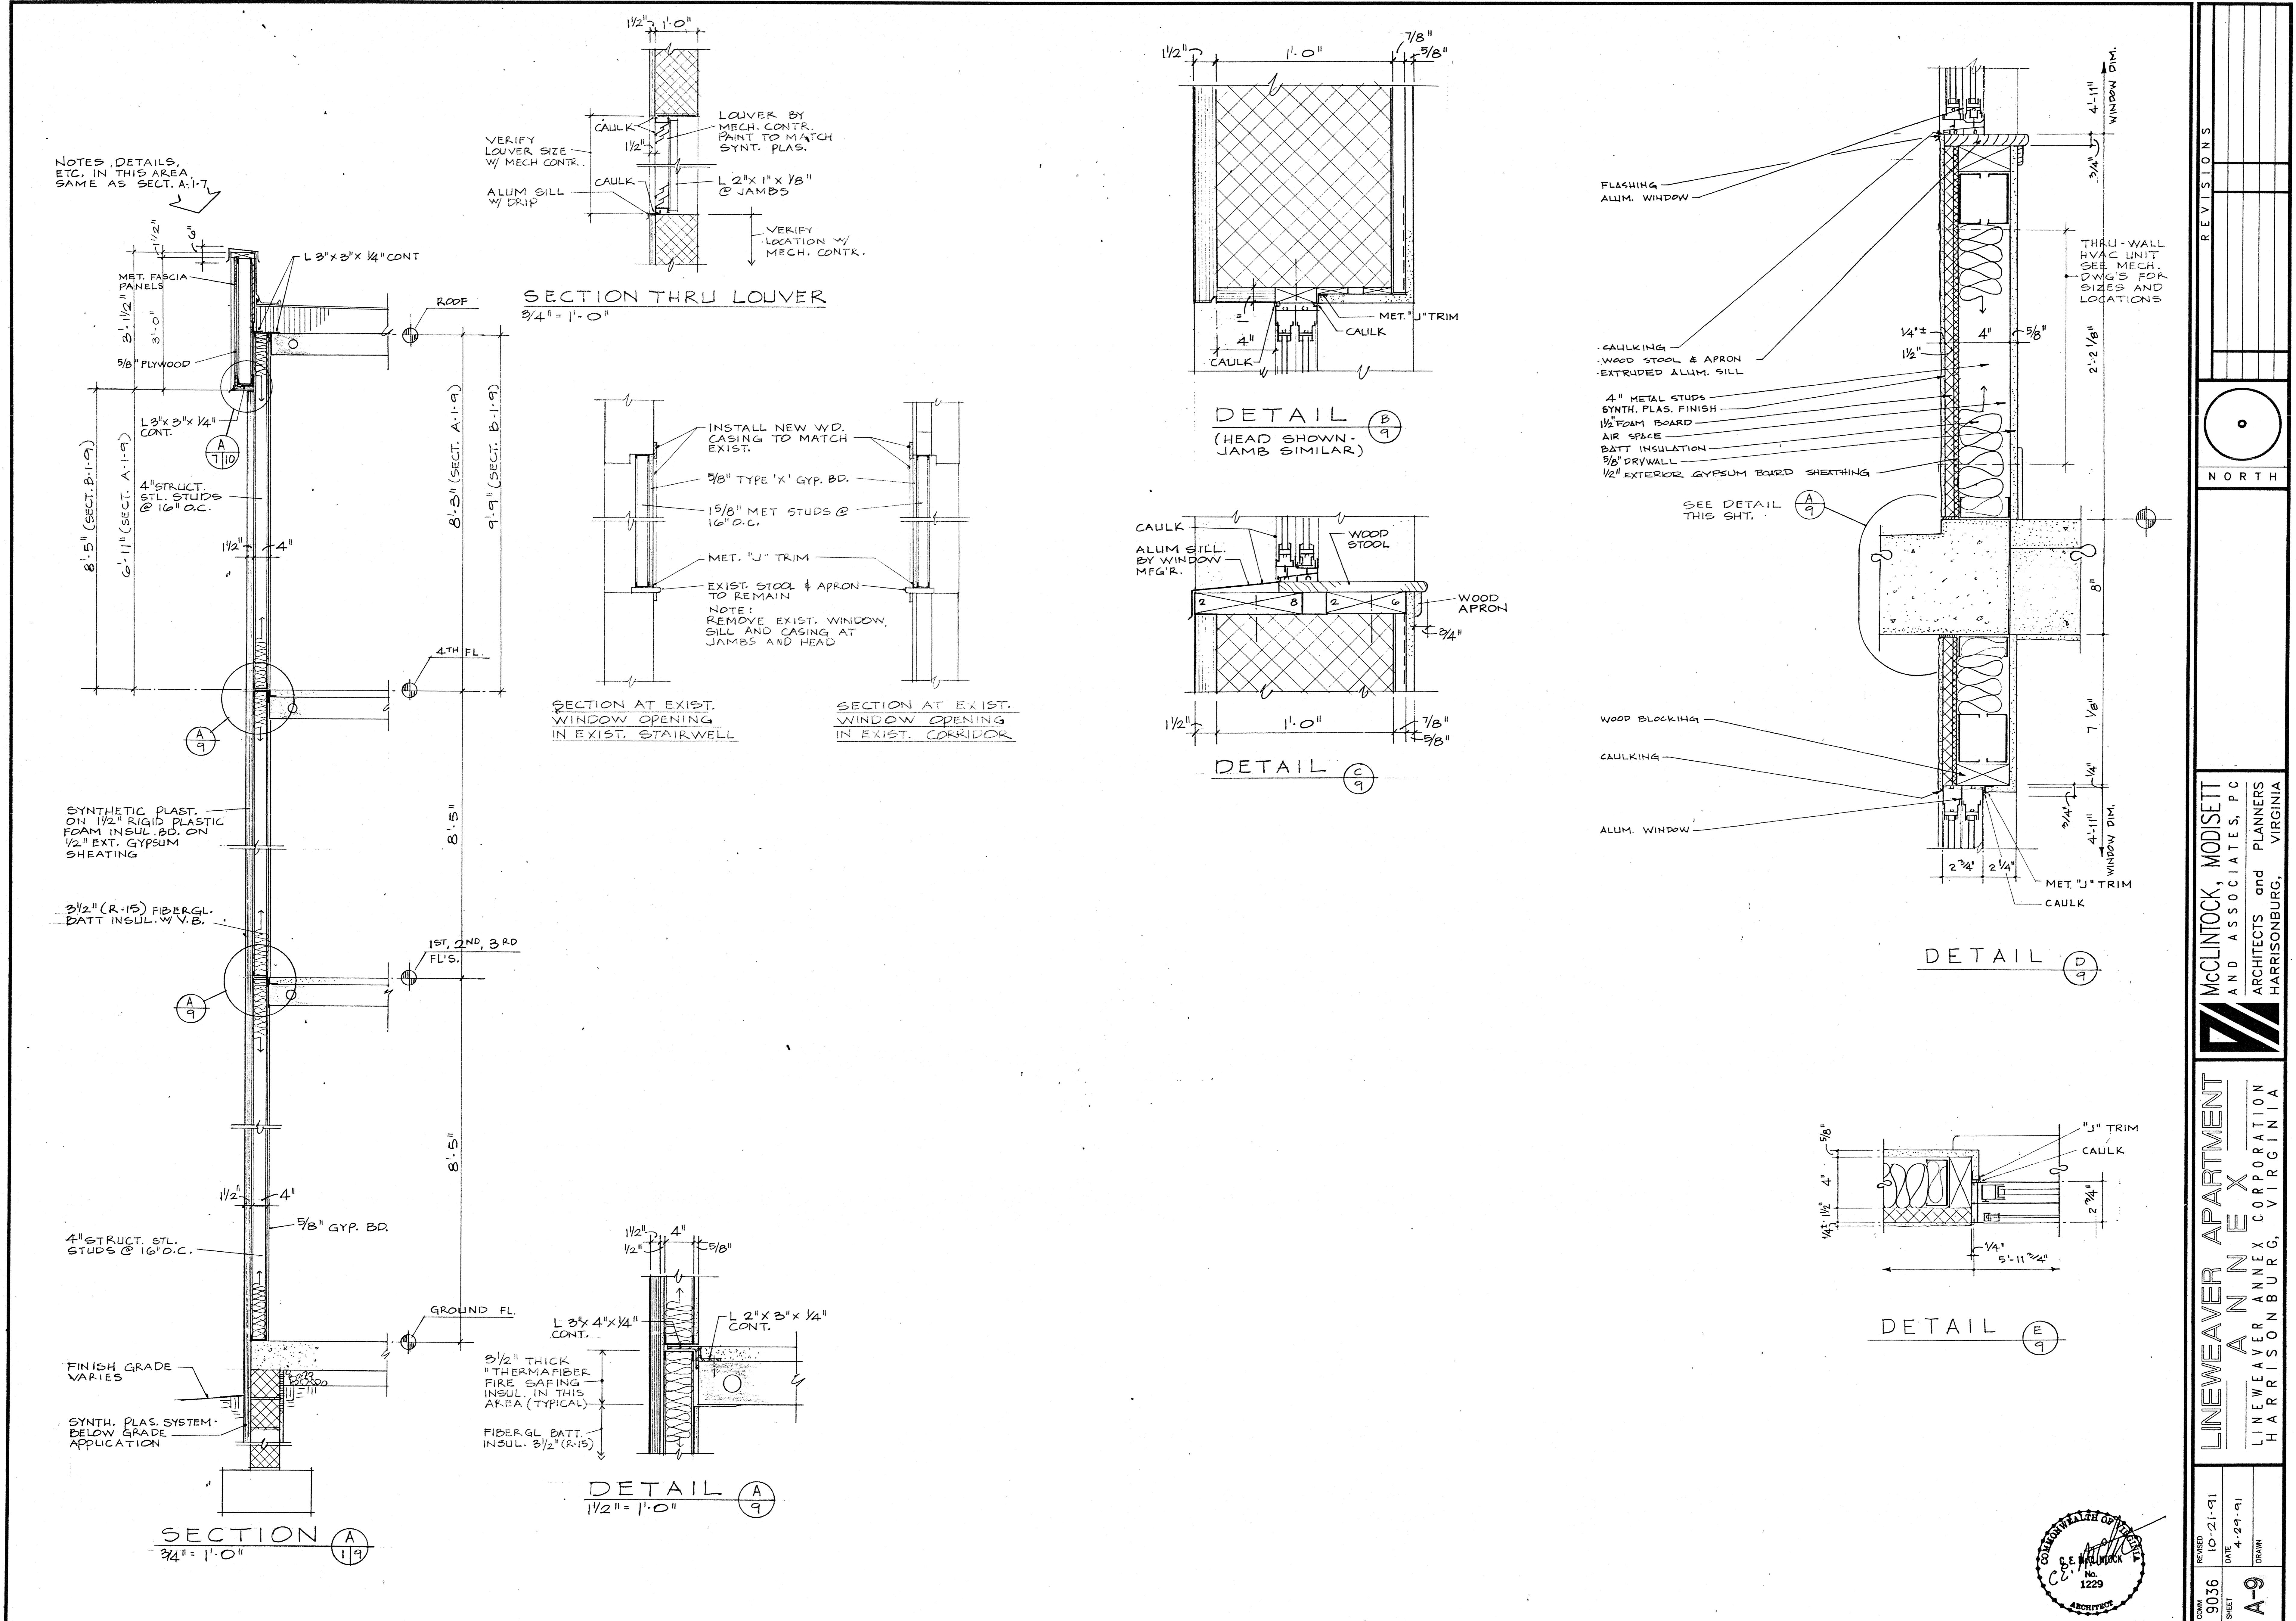


COM: 9036 REV'D: 10-21-91
 SHEET: A-9 DATE: 4-29-91
 DRAWN: C.E. HARRISON BURG, ARCHITECT
 MODISETT, MCCLINTOCK AND ASSOCIATES, PC
 LINEWEAVER ANNEX CORPORATION
 HARRISONBURG, VIRGINIA
 COMMONWEALTH OF VIRGINIA
 CO. NO. 1229
 APPROVED BY: [Circular stamp]


REVISIONS

NORTH

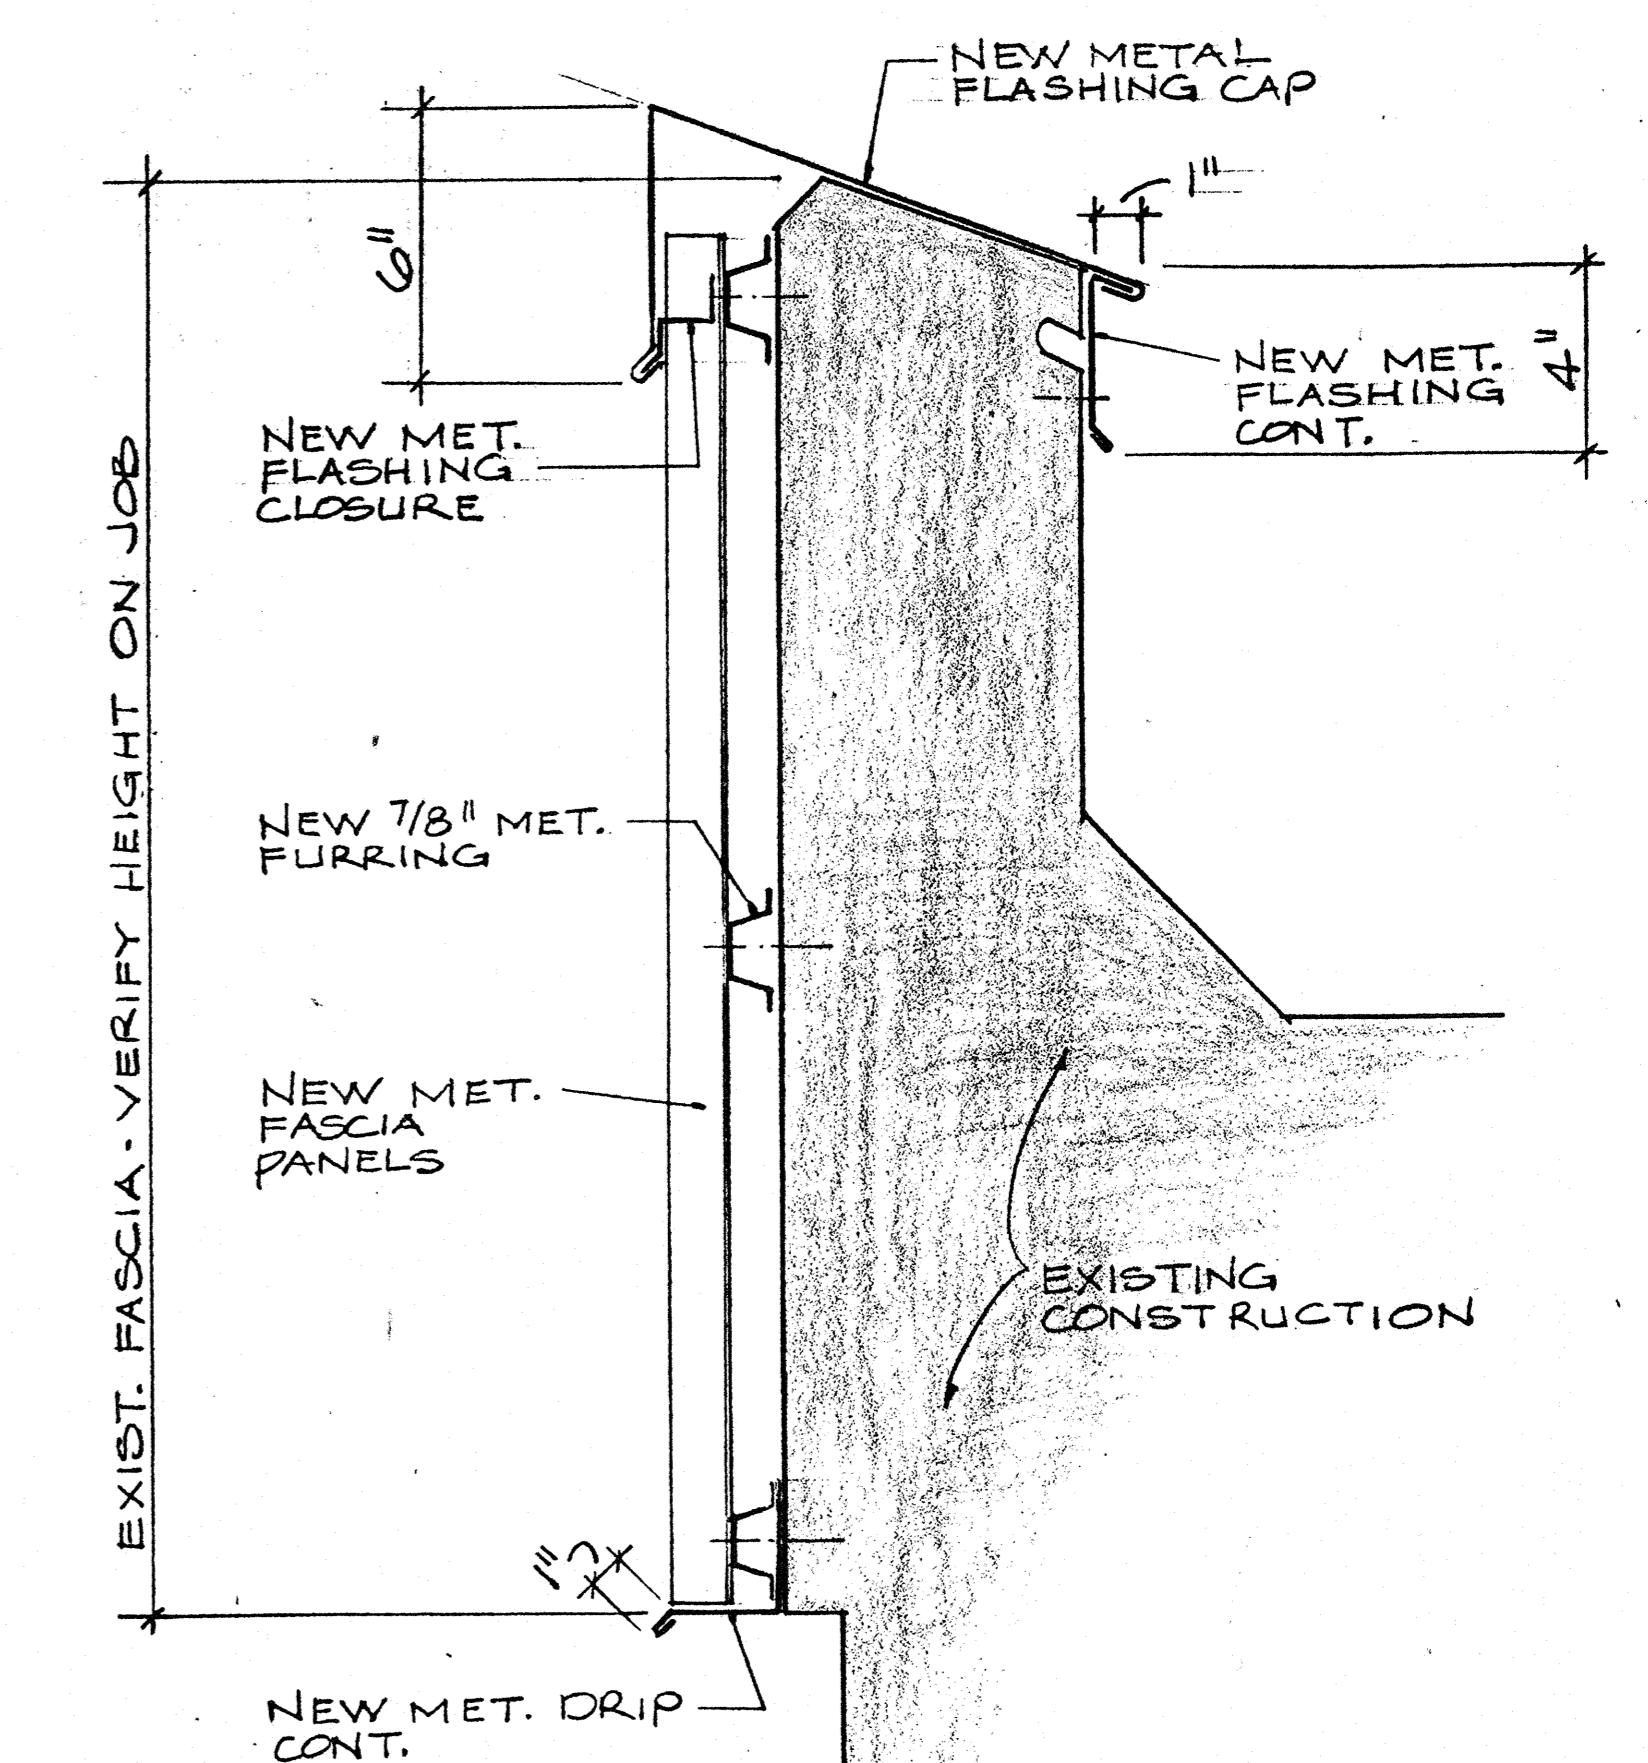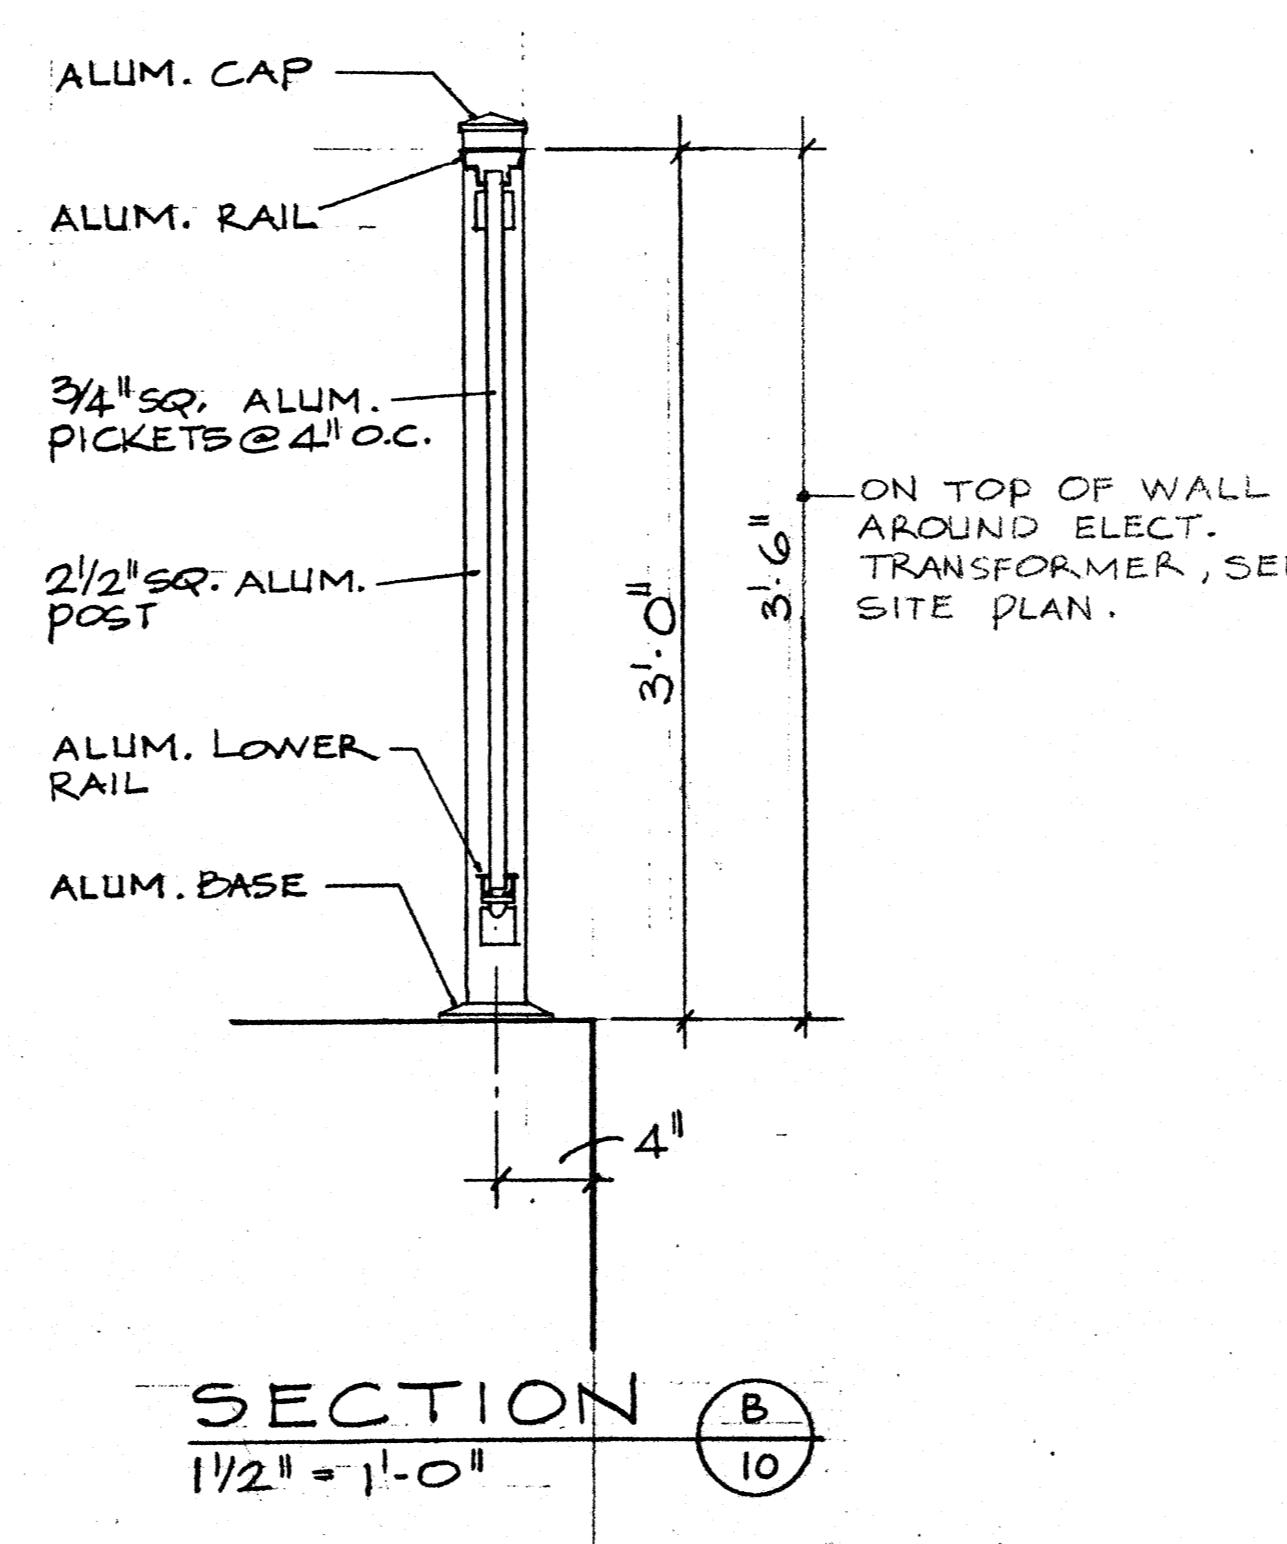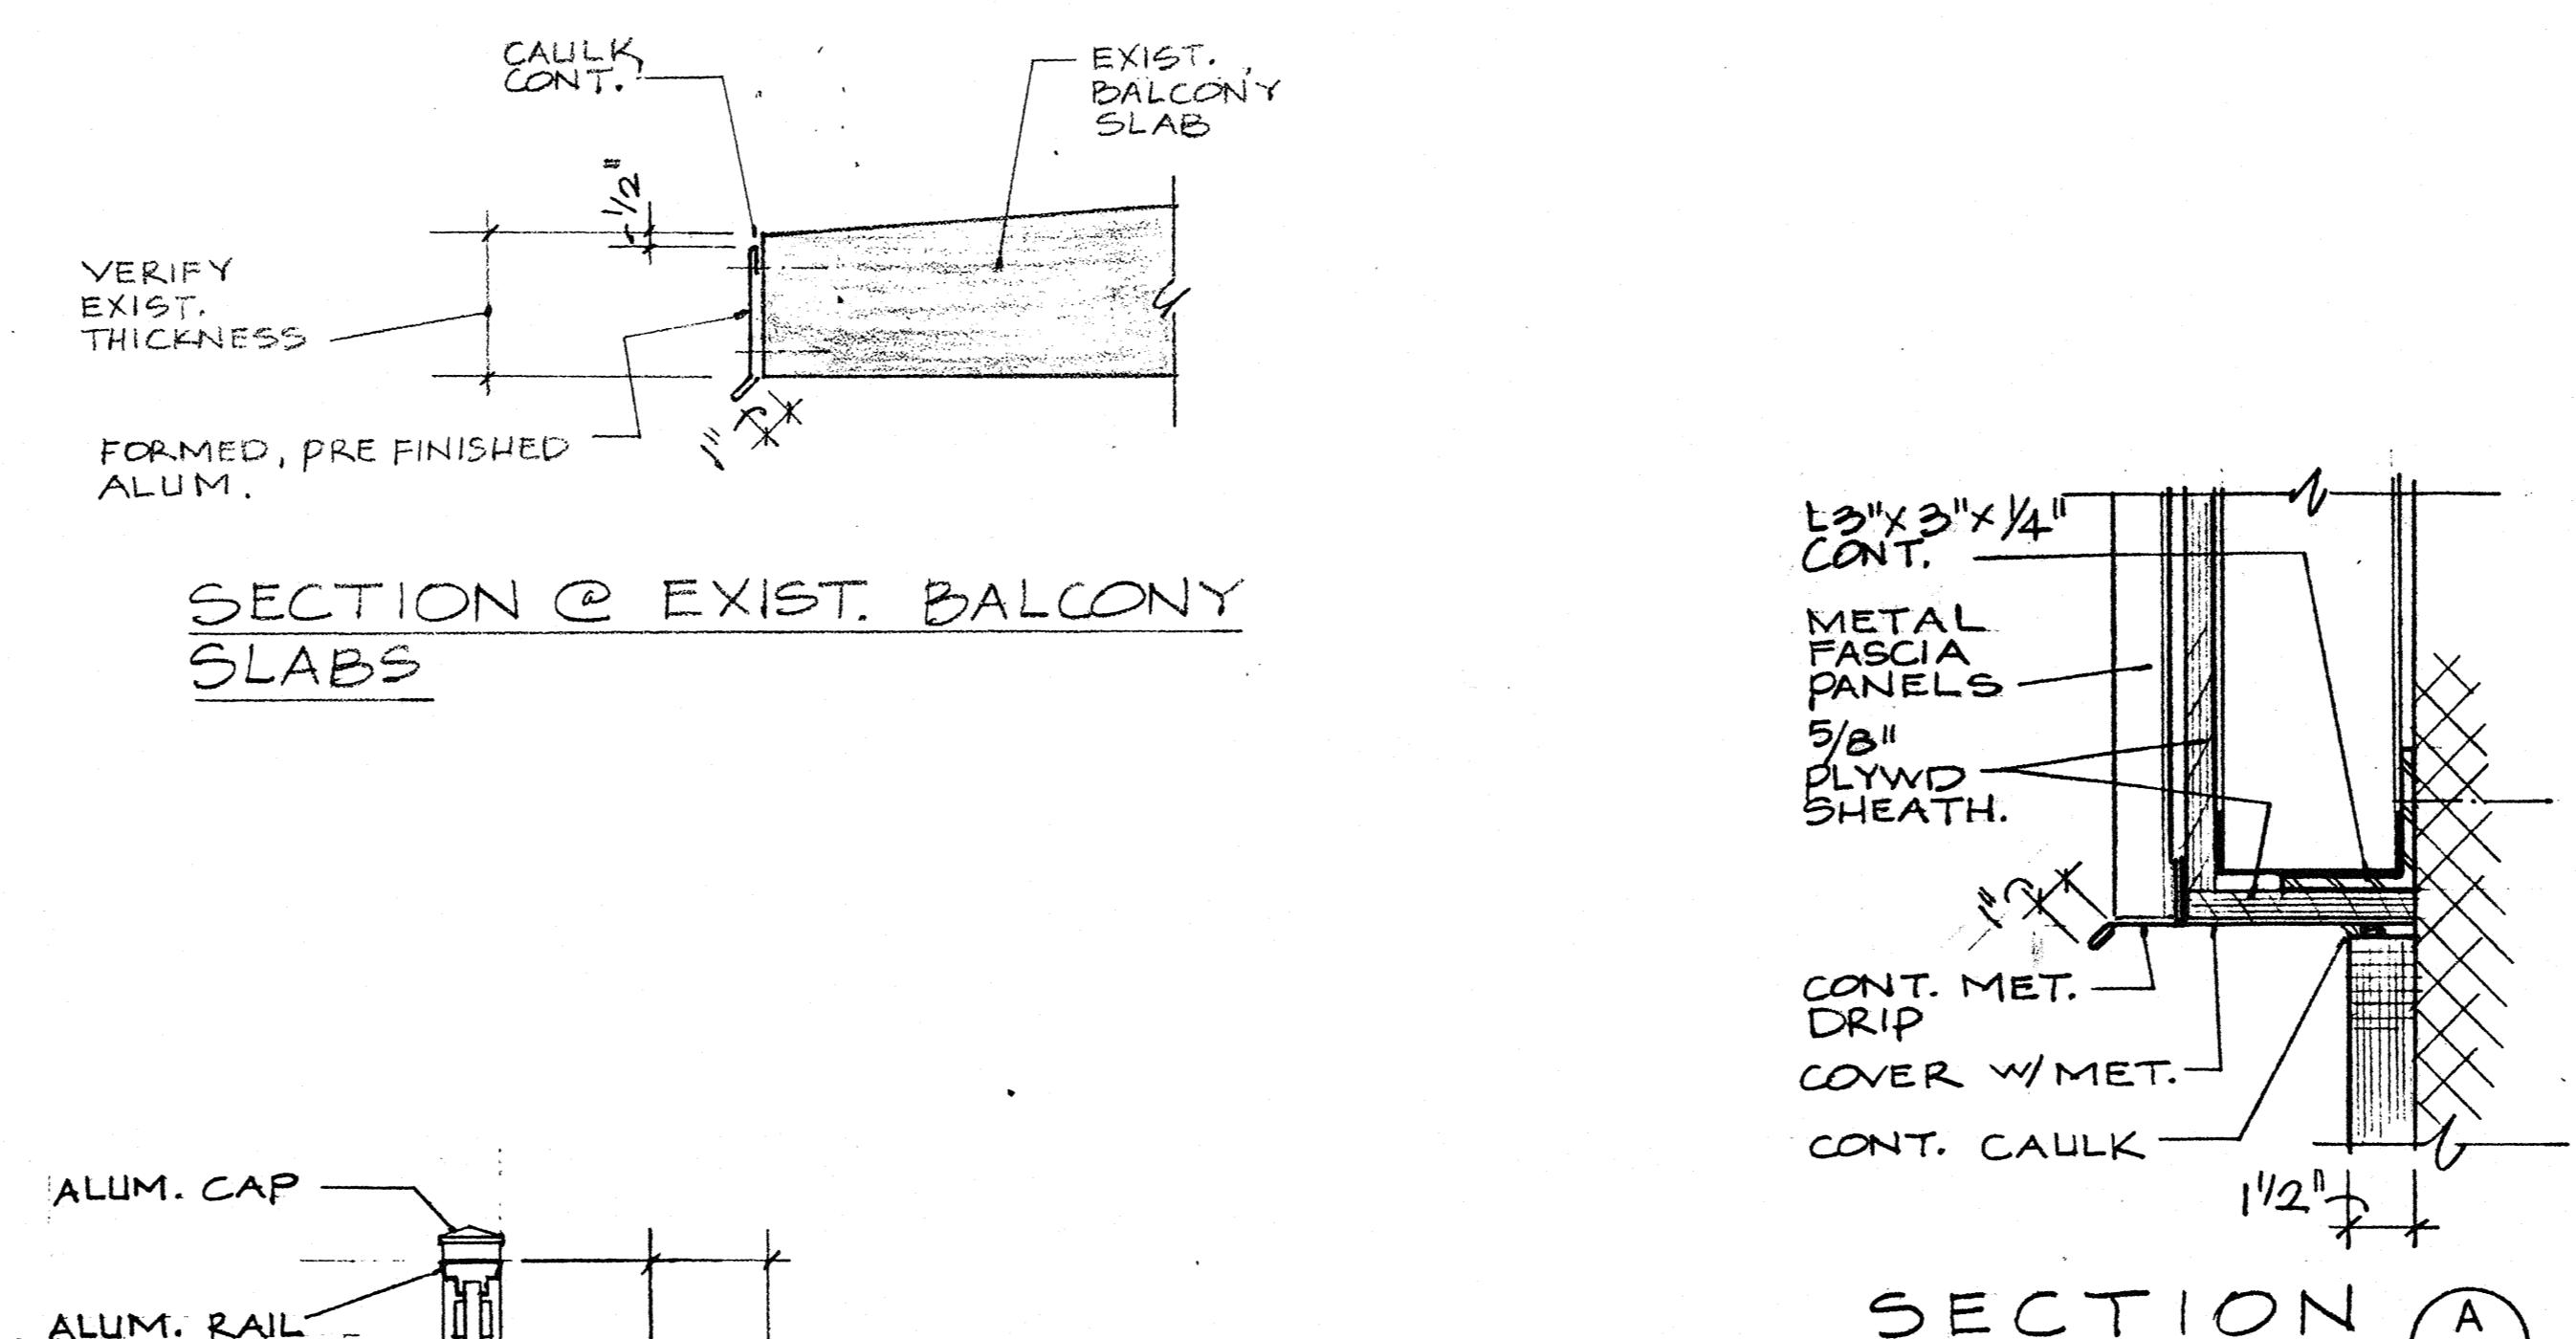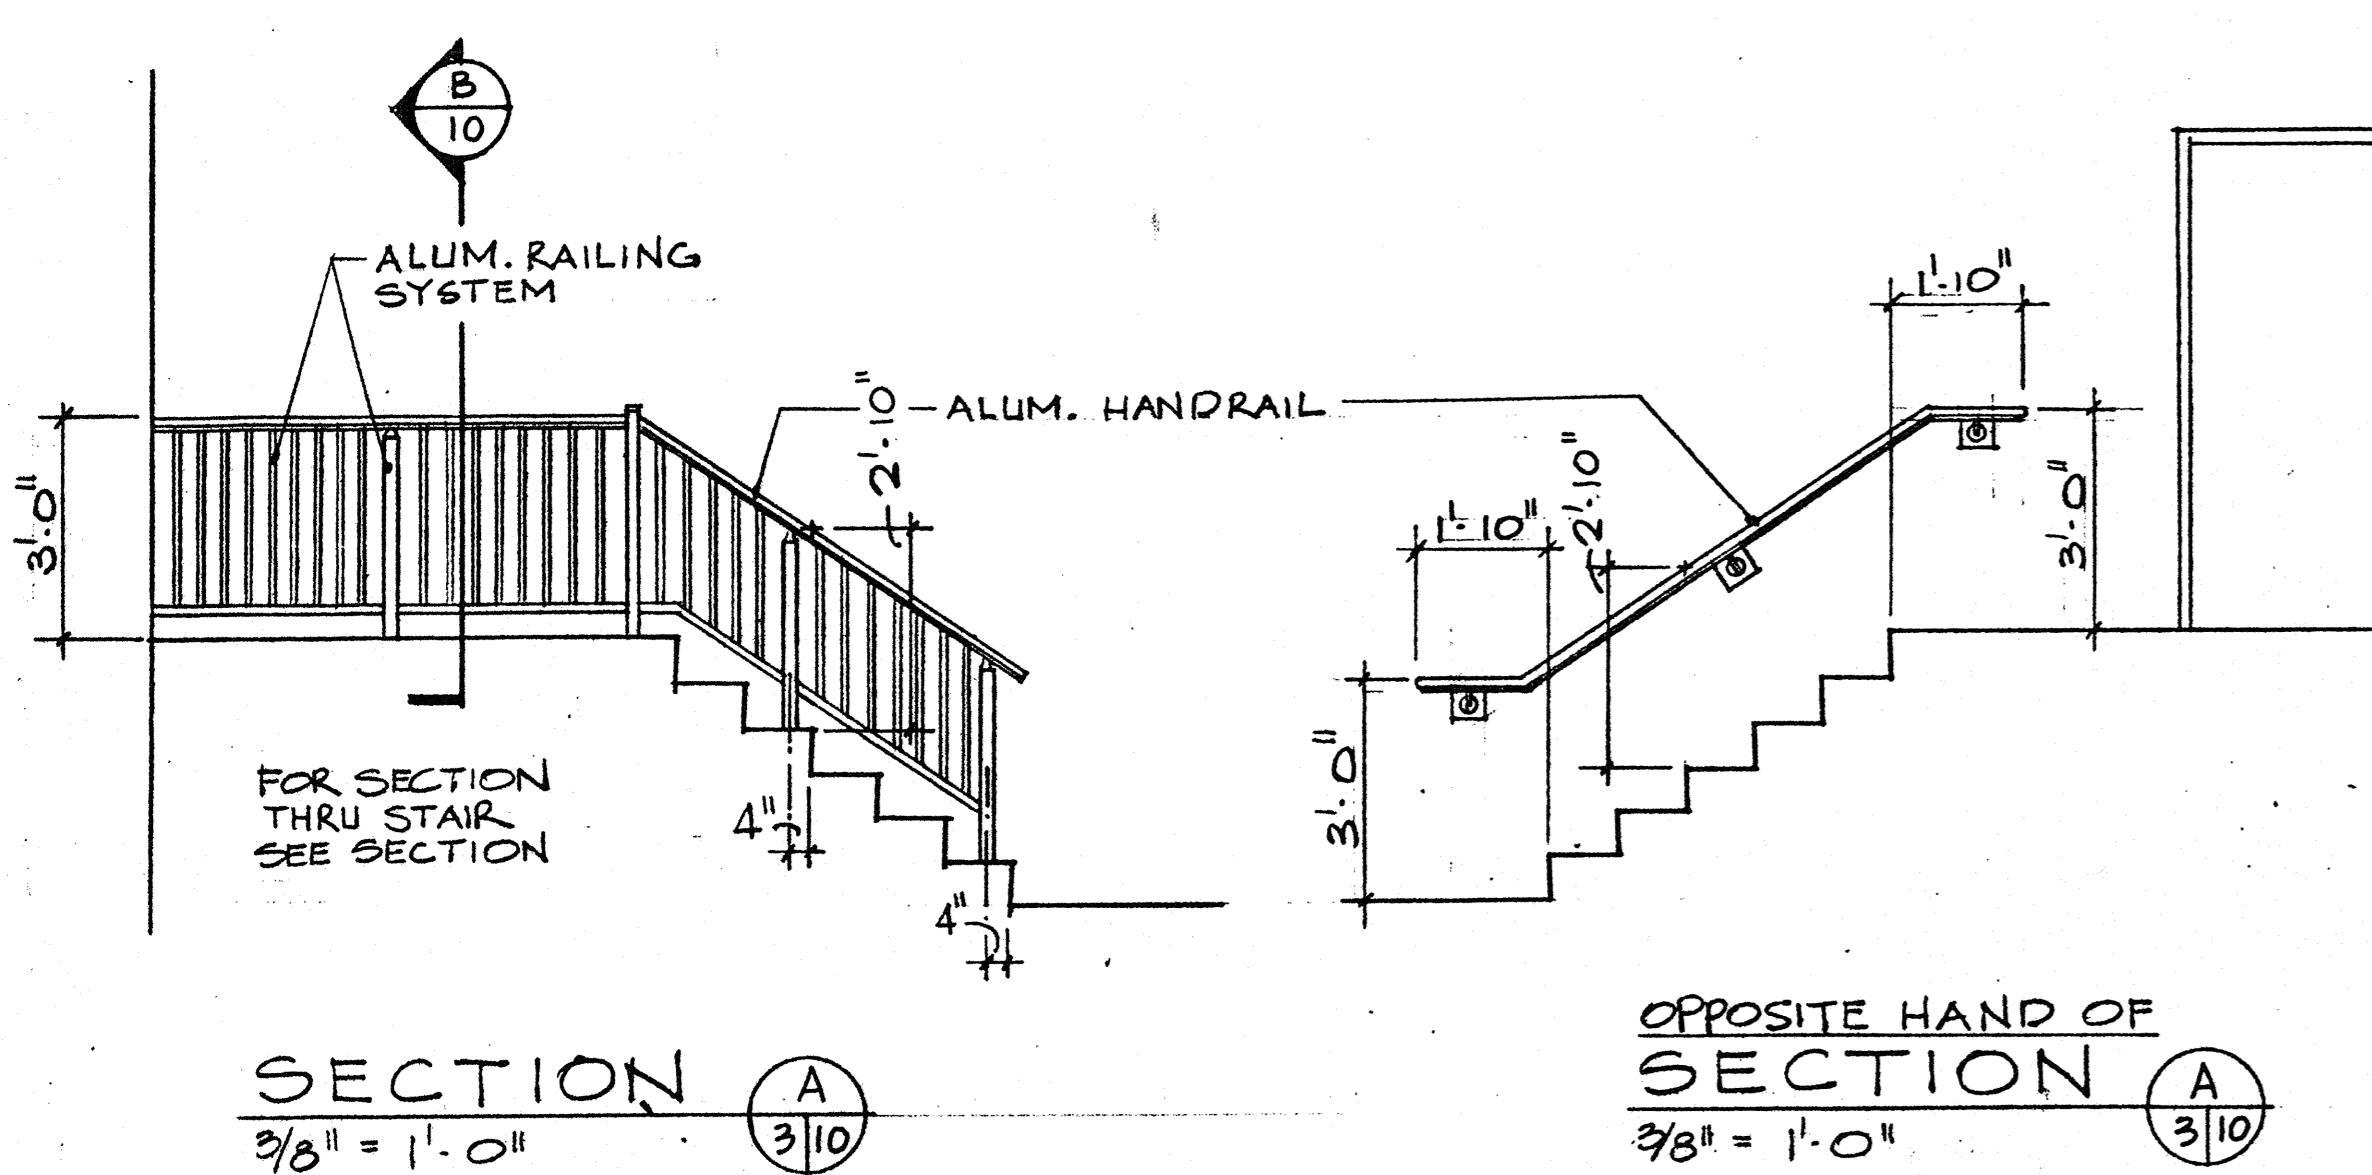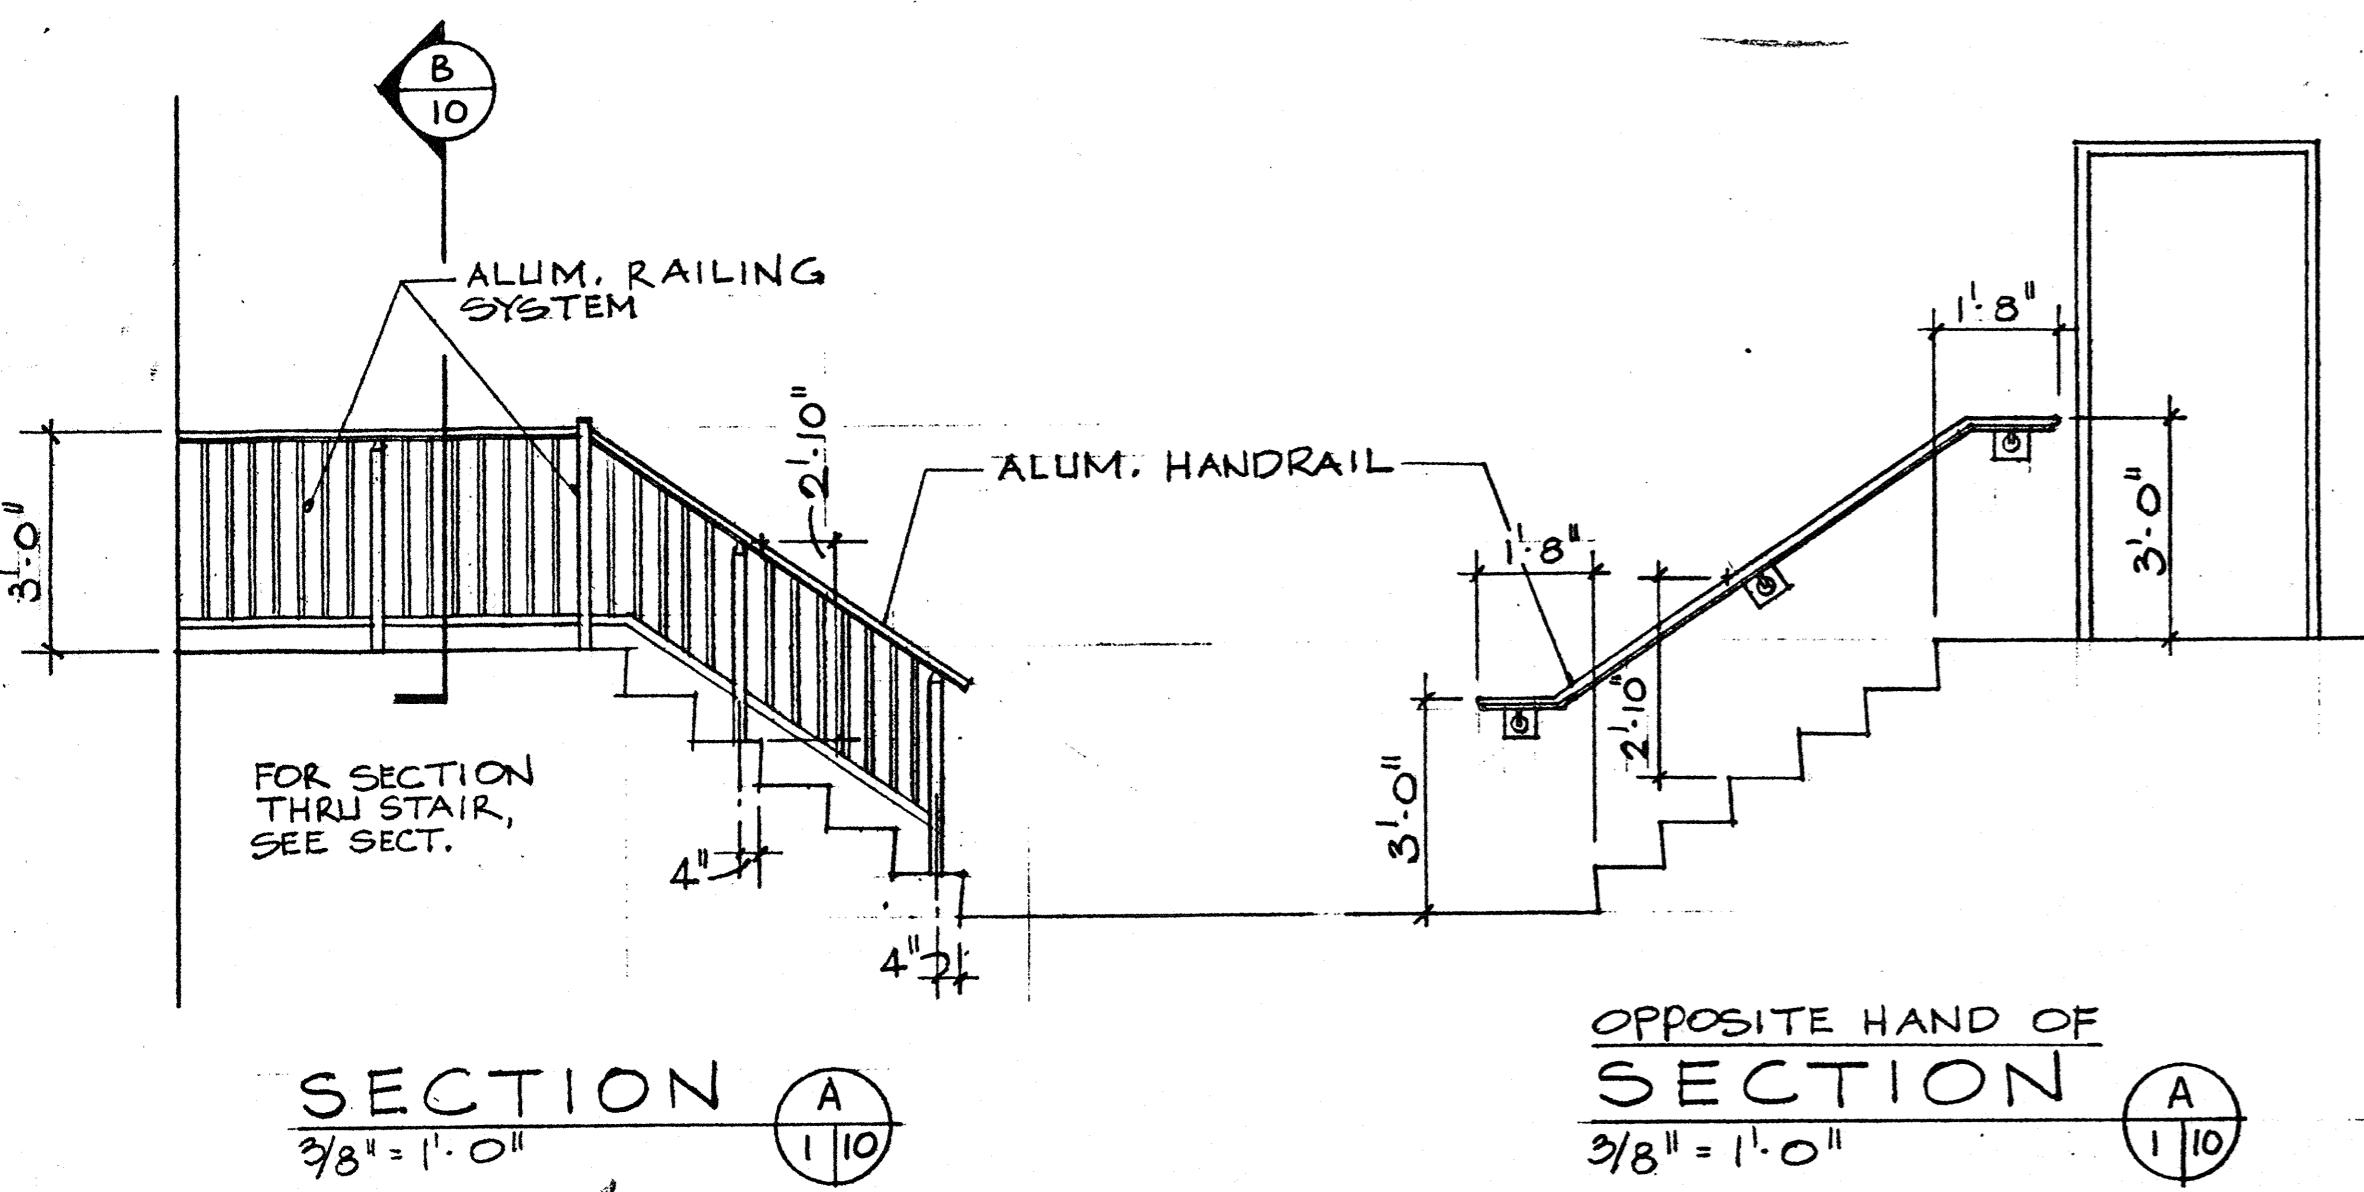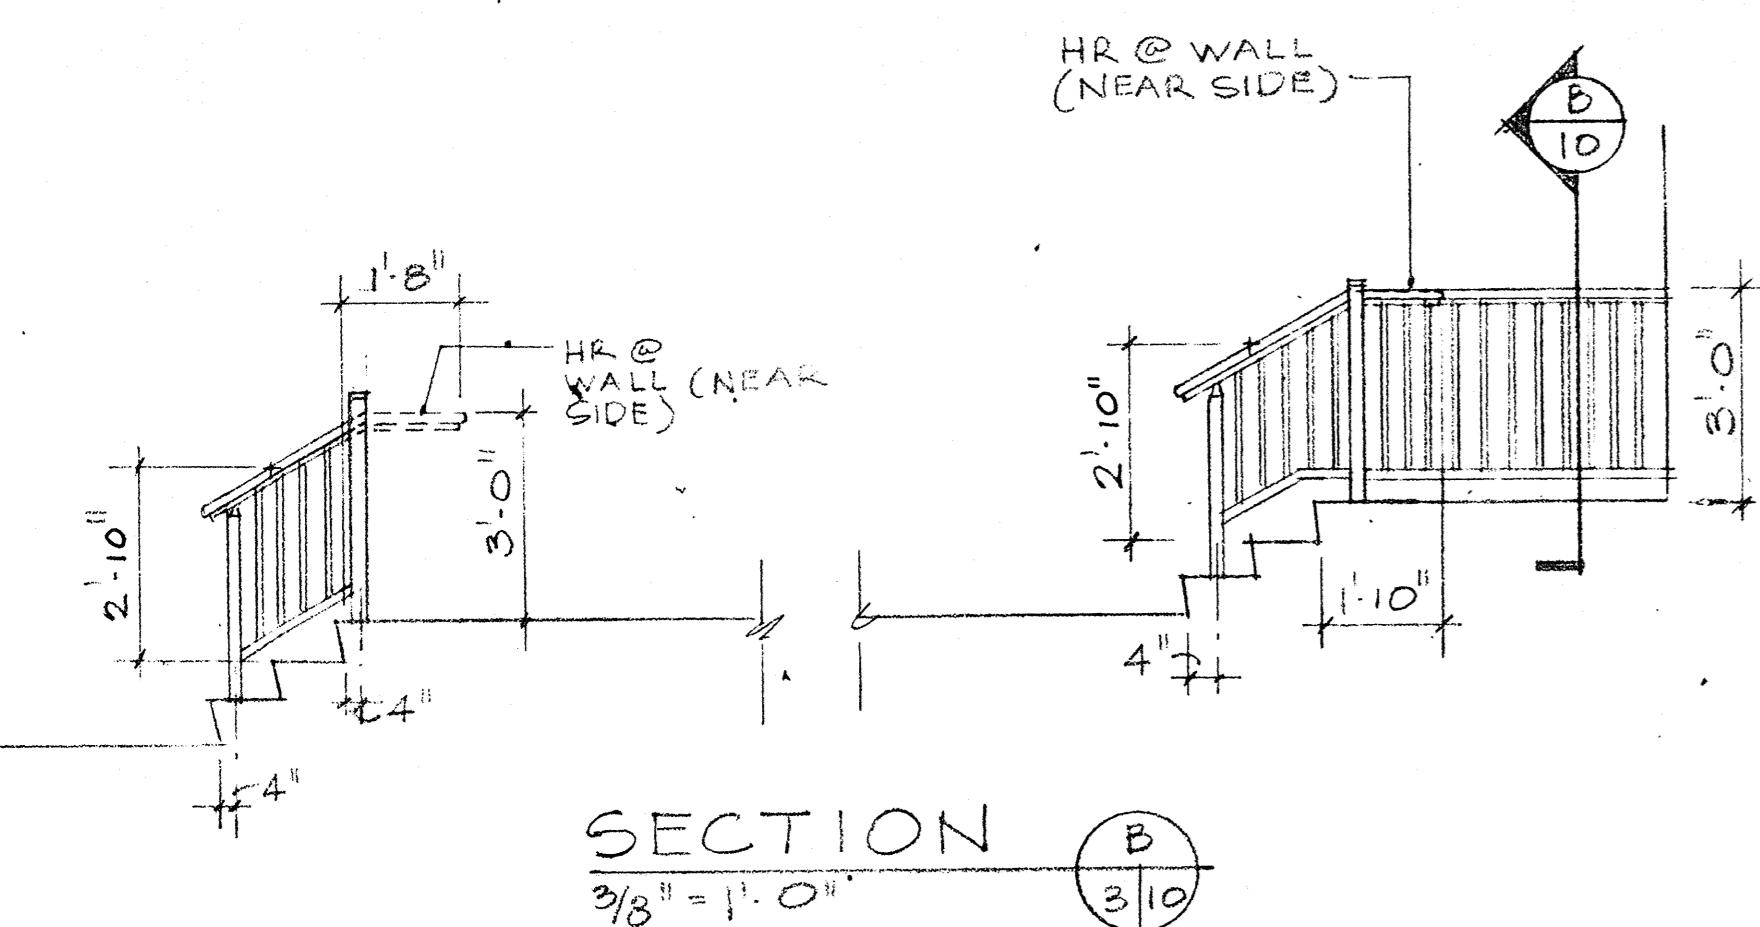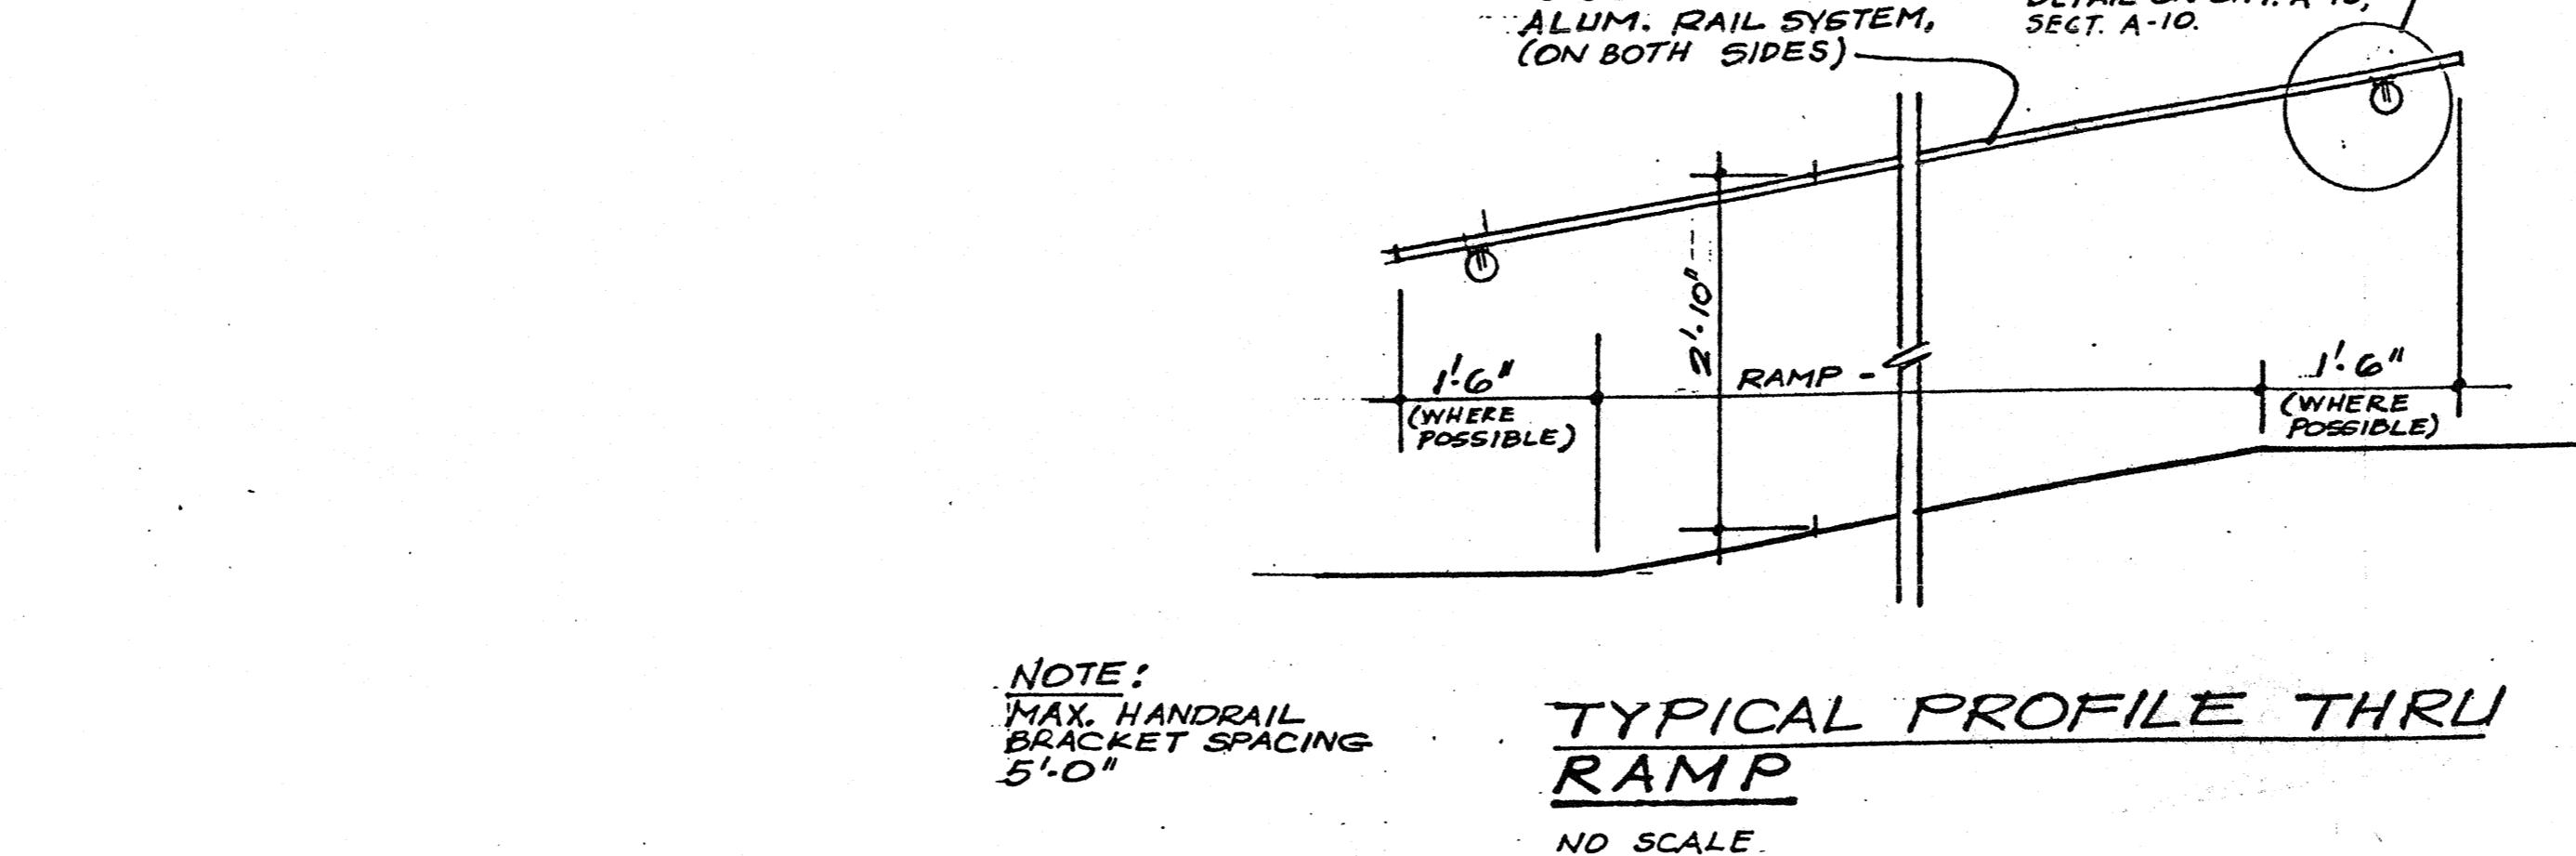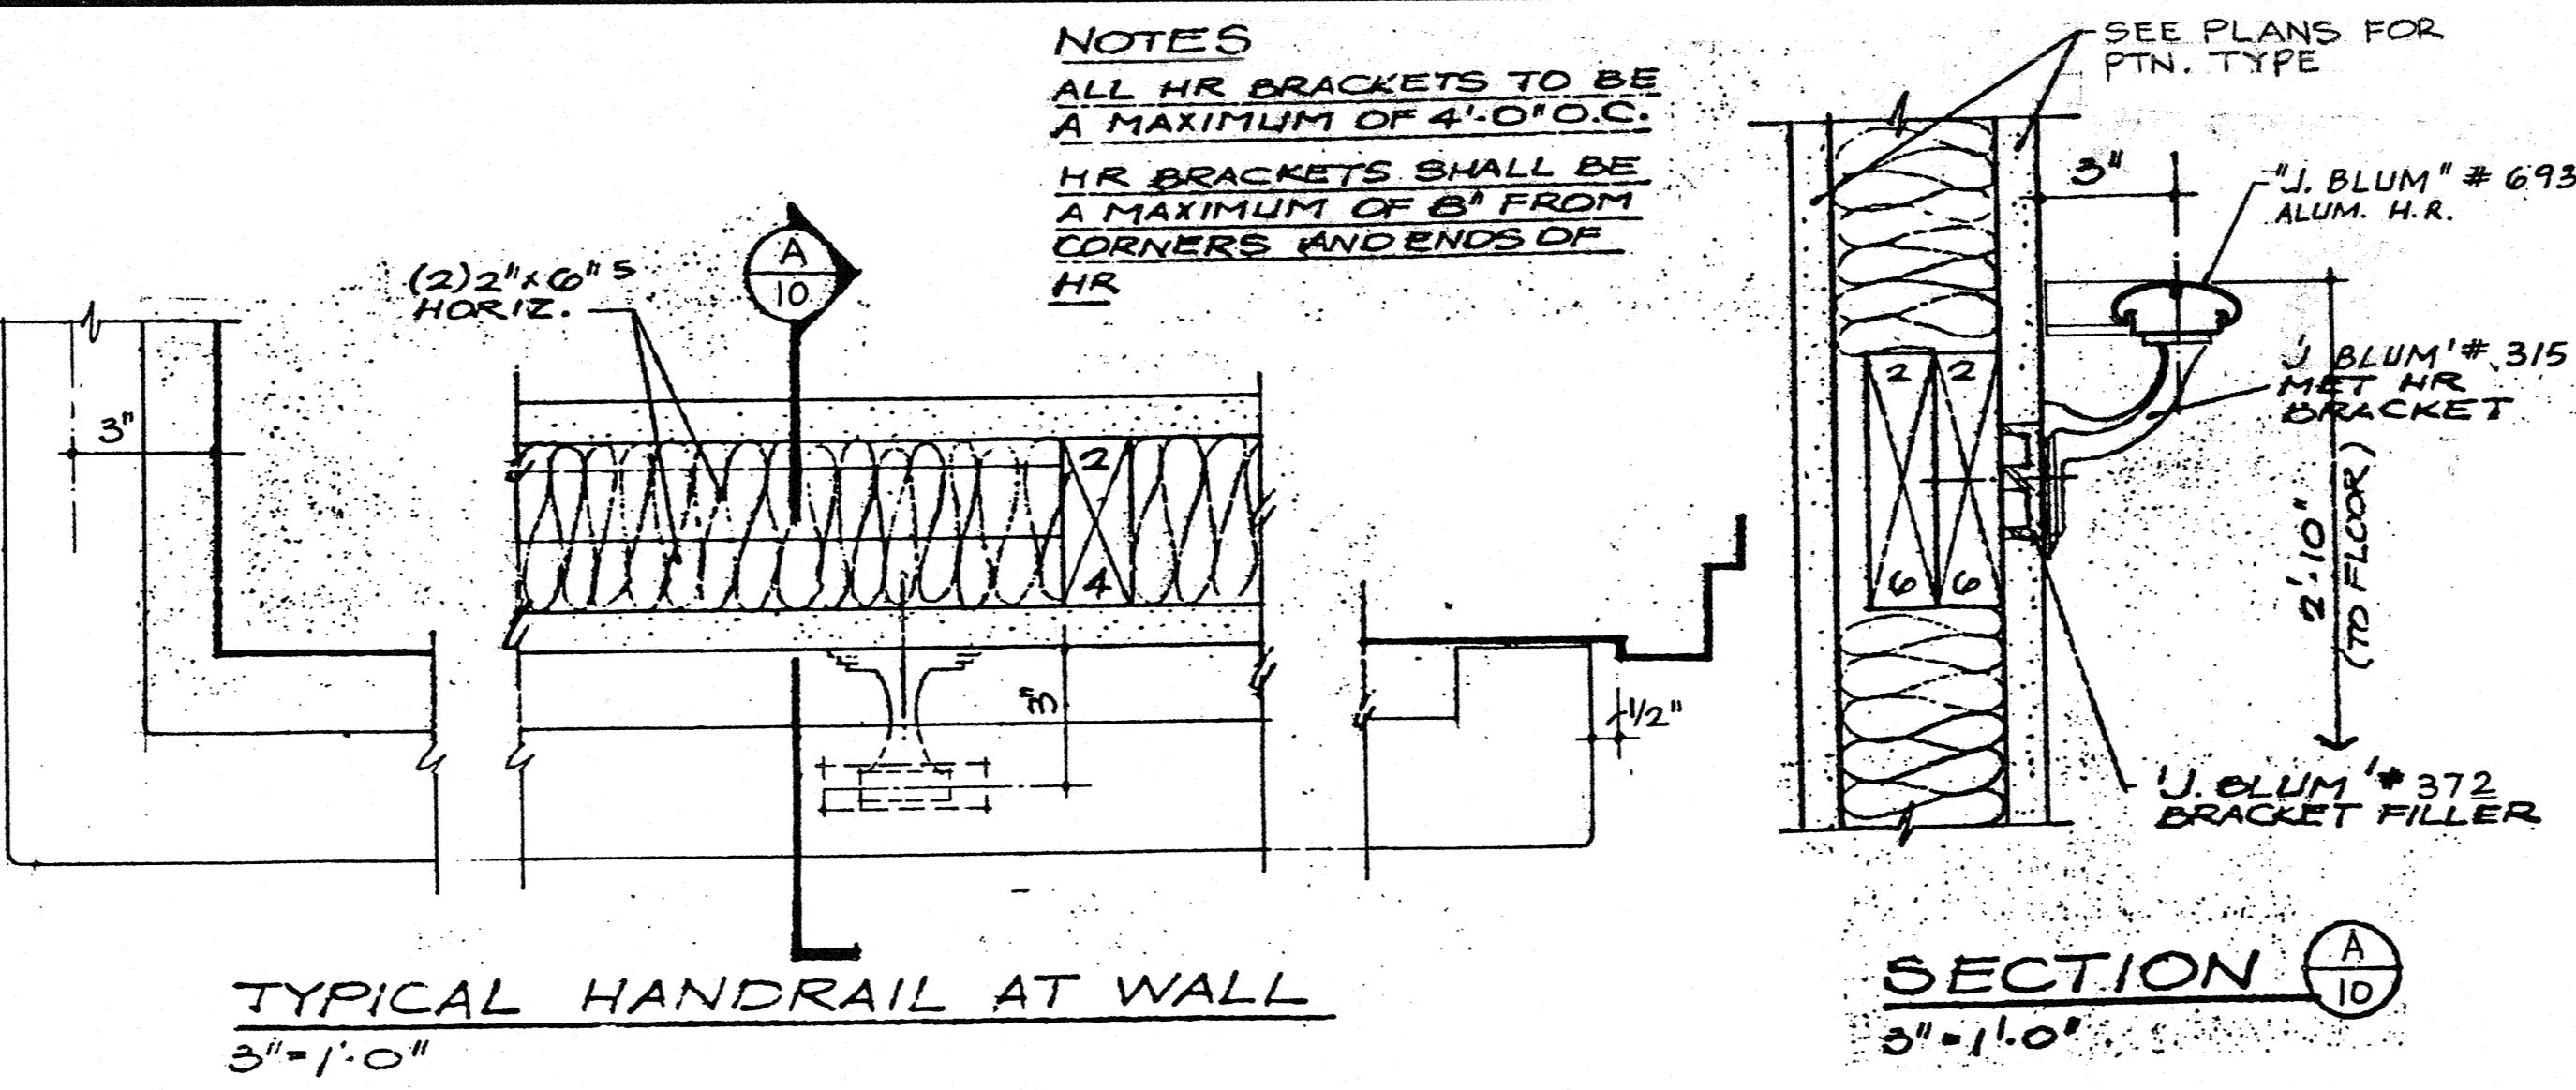McCLINTOCK, MODISETT
AND ASSOCIATES, PC
PLANNERS
HARRISONBURG,
VIRGINIALINEWEAVER APARTMENT
ANNEX
LINEWEAVER ANNEX CORPORATION
HARRISONBURG, VIRGINIACOM: 9036 REV'D: 10-21-91
SHEET: A-10 DATE: 4-29-91
DRAWN: C.E. McCLINTOCK
No. 1229
ARCHITECT

SECTION THRU EXIST. FASCIA

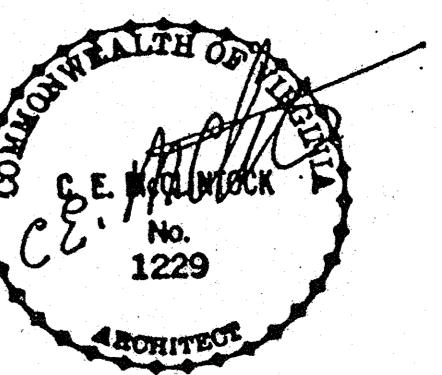

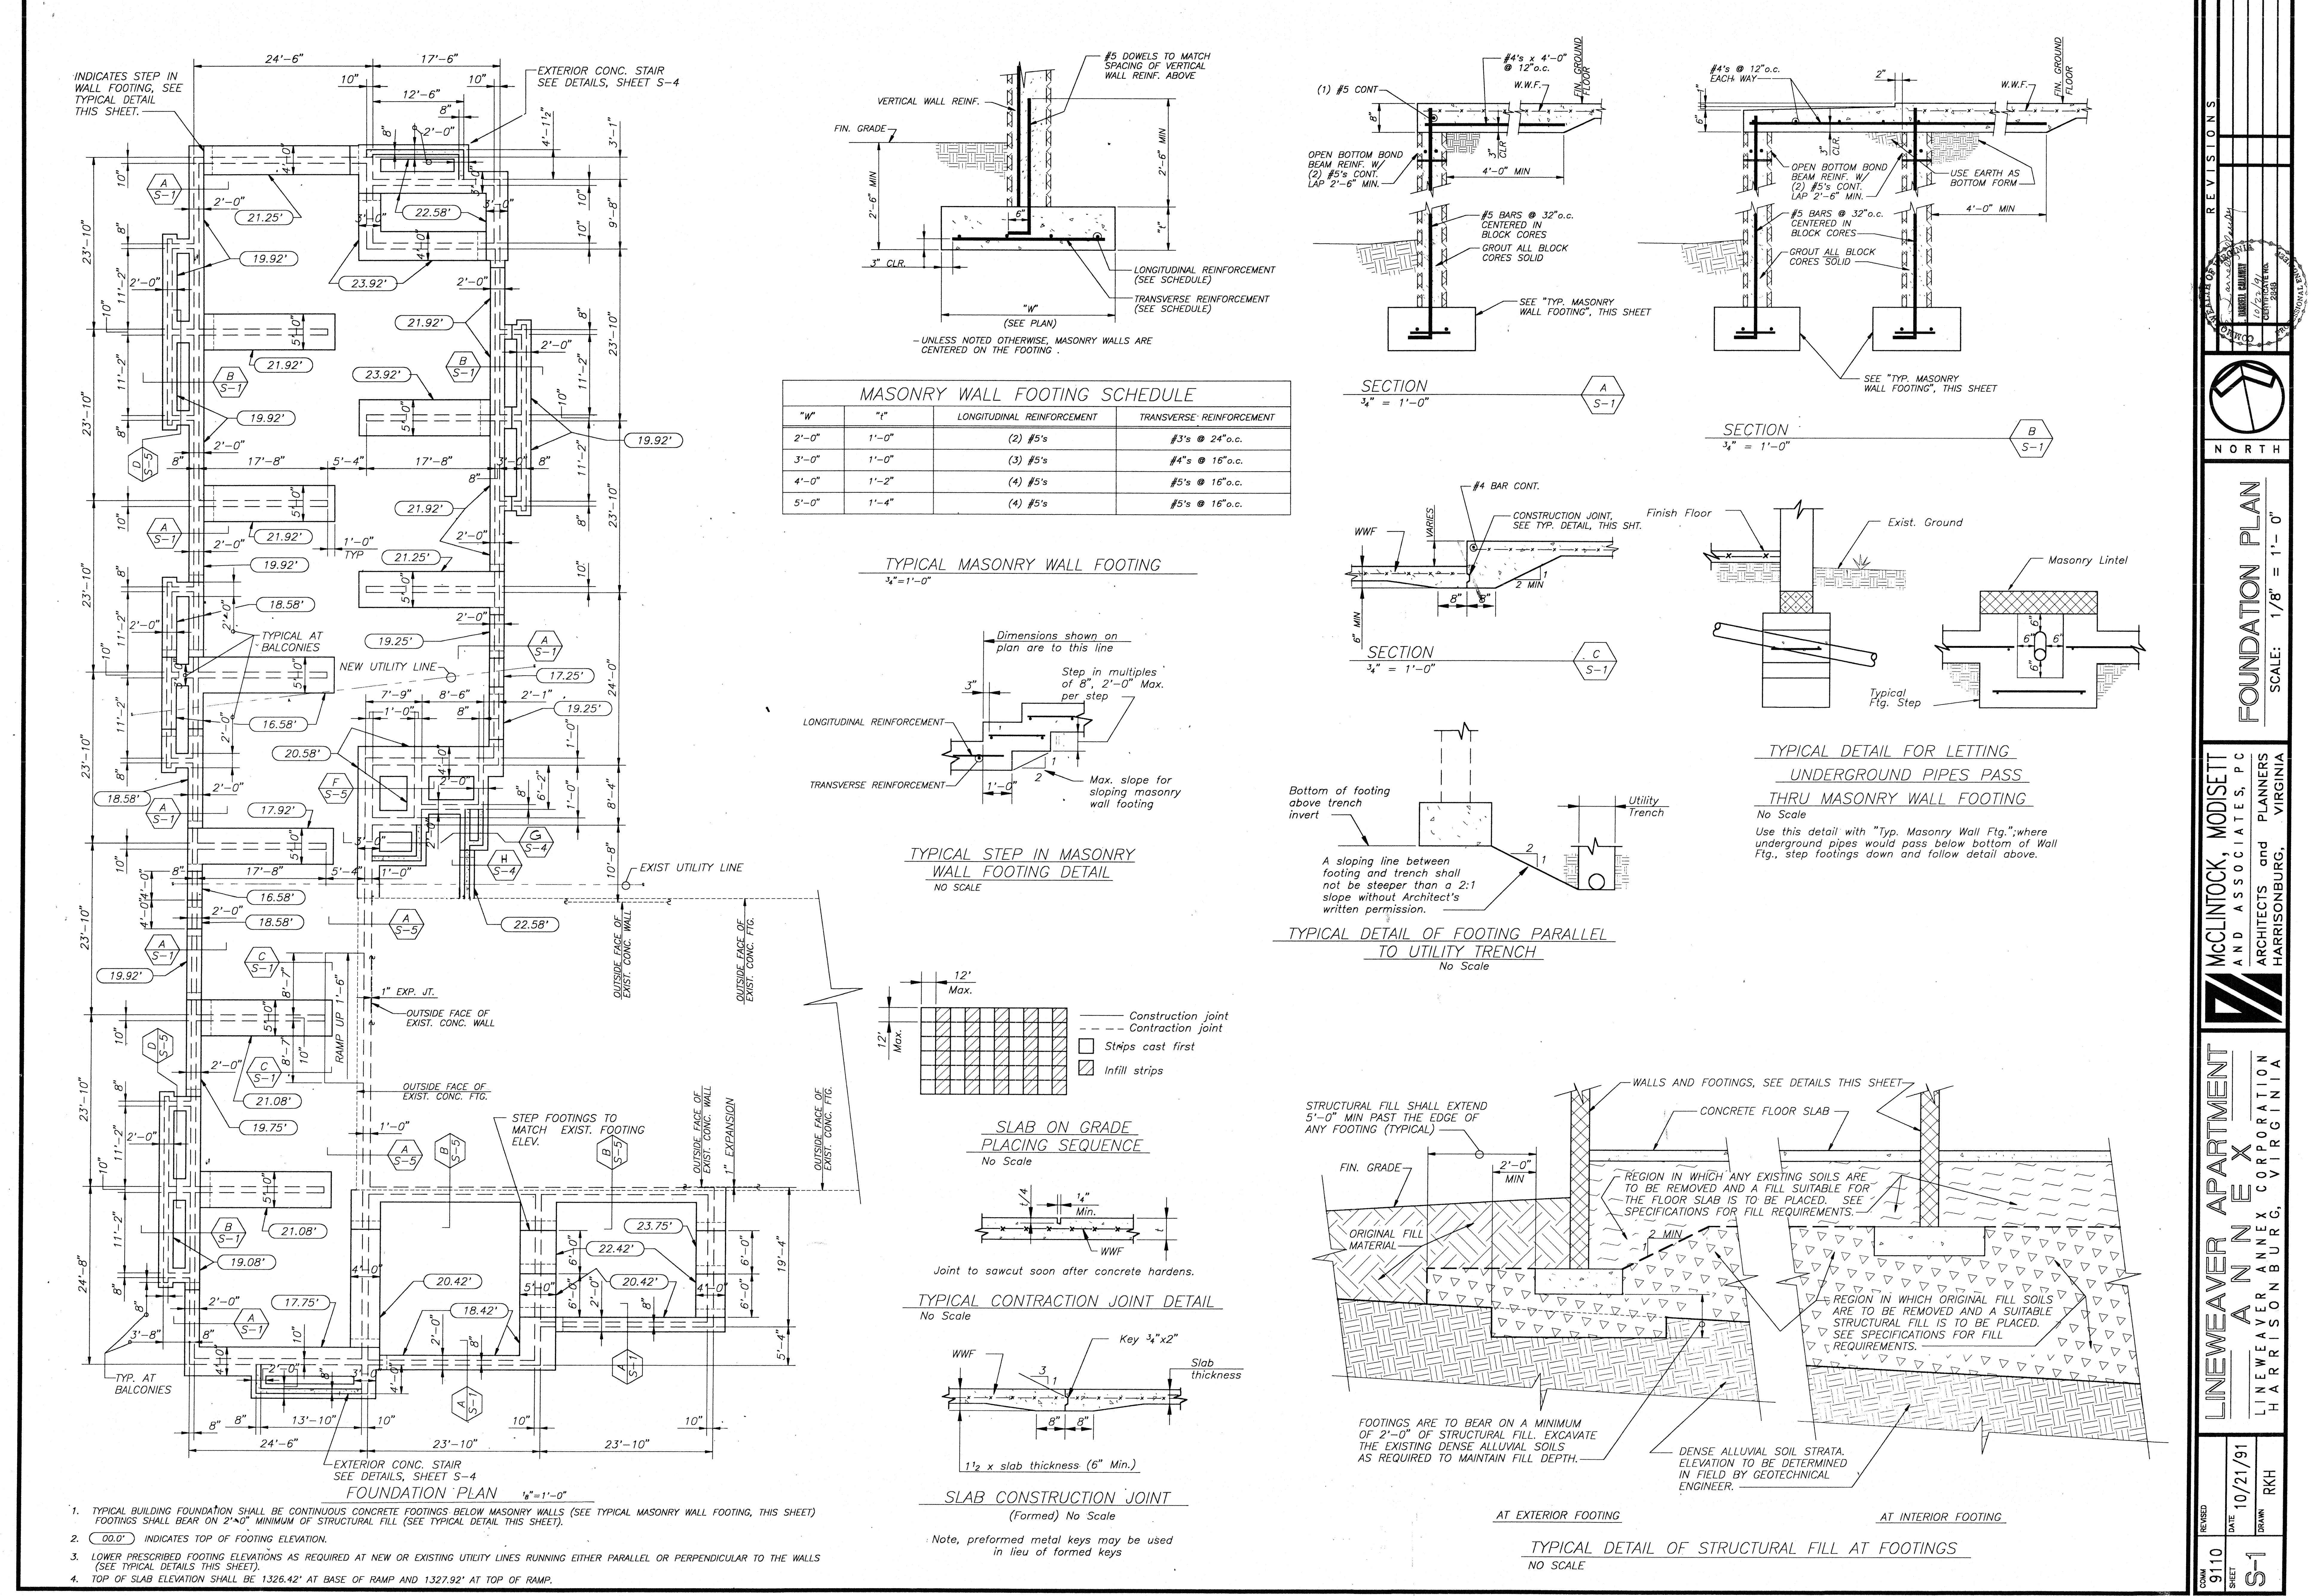


S-2

REVISIONS
10-1-91
S-2

McCLINTOCK, MODISSETT
AND ASSOCIATES, P.C.
ARCHITECTS and PLANNERS
HARRISONBURG, VIRGINIA

LINEWEAVER APARTMENT
LINEWEAVER ANNEX CORPORATION
HARRISONBURG, VIRGINIA

SHEET 9110 REVISED DATE 10/21/91
SHEET S-2 DRAWN RKH

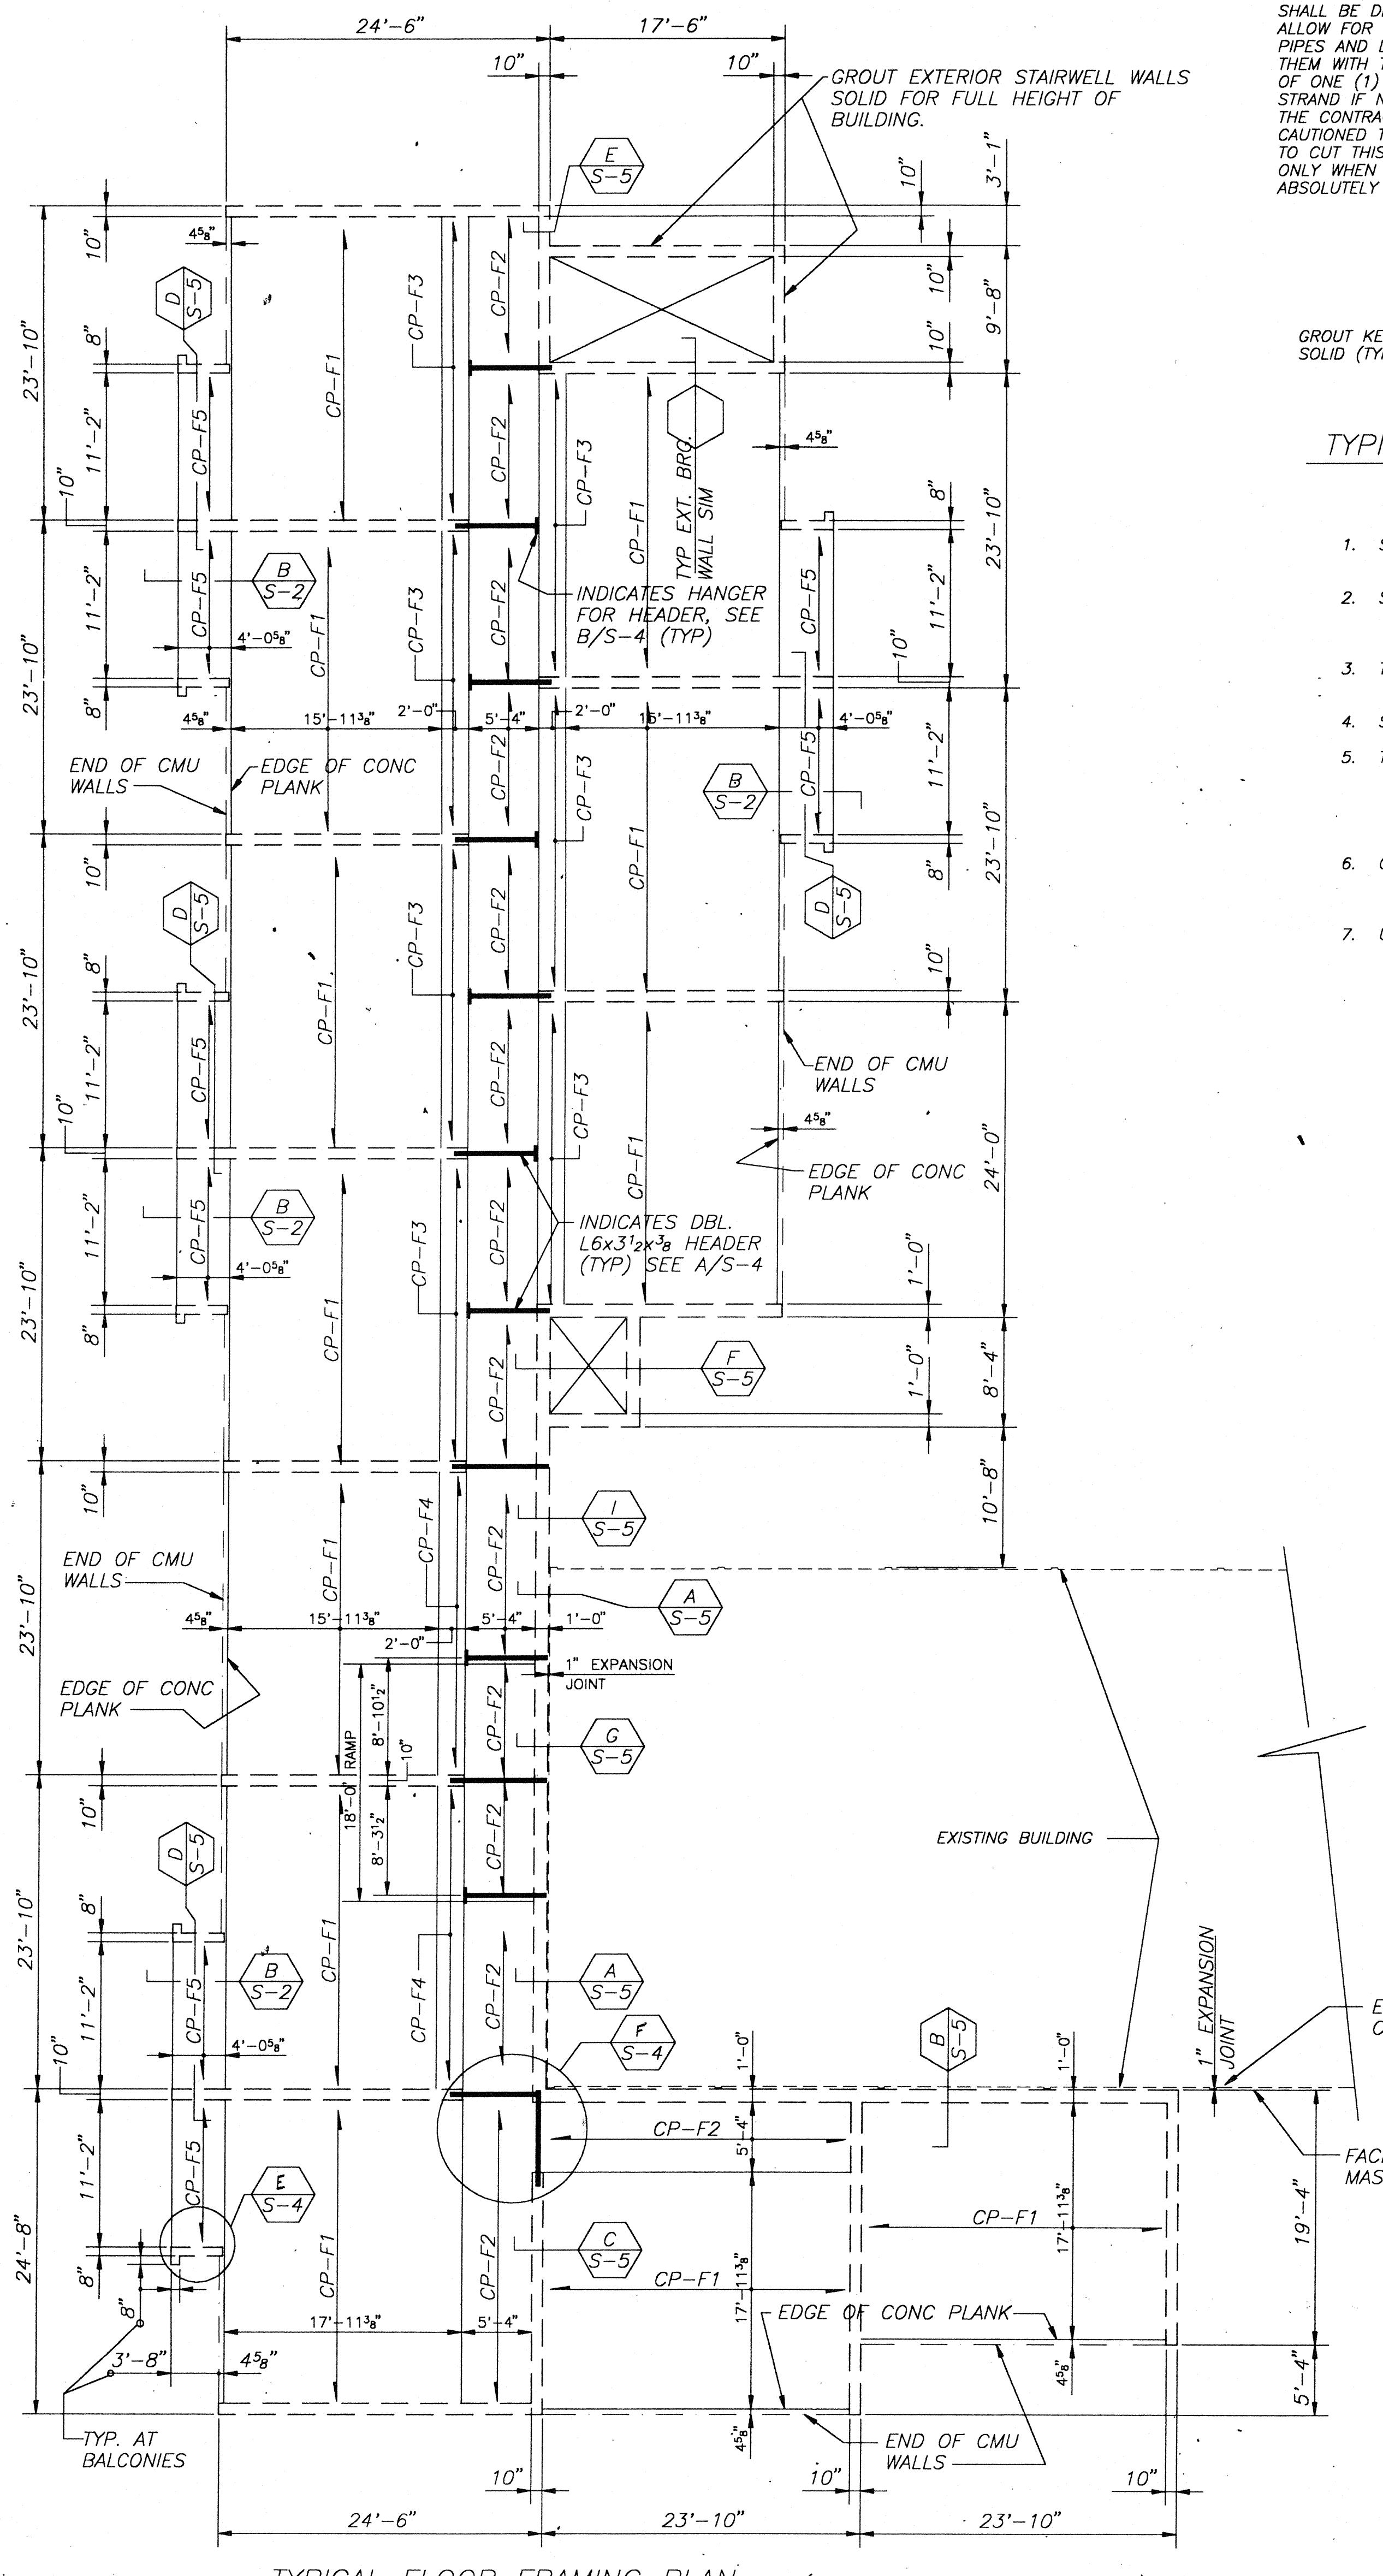


TYPICAL FLOOR FRAMING PLAN (1st, 2nd, 3rd AND 4th FLOORS) $\frac{1}{8}$ " = 1'-0"

1. TYPICAL FLOOR FRAMING SHALL BE 6" PRECAST CONCRETE PLANKS TOPPED WITH 2" OF REGULAR WEIGHT CONCRETE.
2. TOP OF FINISHED FLOOR ELEVATIONS ARE AS FOLLOWS:

AT BASE OF RAMP:
 1st FLOOR=1334.83'
 2nd FLOOR=1343.25'
 3rd FLOOR=1351.67'
 4th FLOOR=1360.08'

AT TOP OF RAMP:
 1st FLOOR=1336.33'
 2nd FLOOR=1344.75'
 3rd FLOOR=1353.17'
 4th FLOOR=1361.42'


3. CP-FX INDICATES PRECAST CONCRETE FLOOR PLANKS. SEE TYPICAL SECTION AND LOADING DIAGRAMS, THIS SHEET.

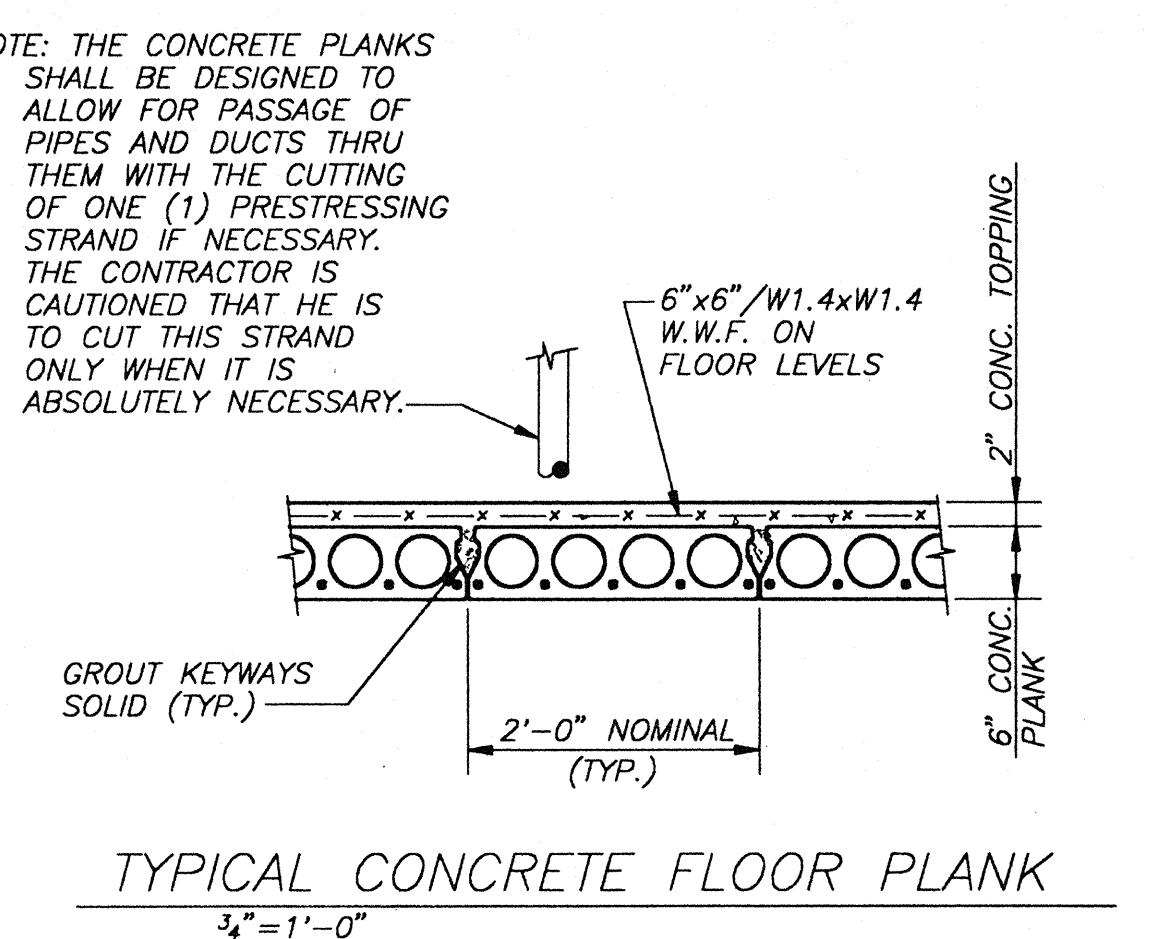

TYPICAL CONCRETE FLOOR PLANK



CONCRETE PLANK NOTES

1. SPACING OF CONCRETE PLANK UNITS IS SHOWN ON FLOOR FRAMING PLANS.
2. SEE BOTH ARCHITECTURAL AND STRUCTURAL DRAWINGS FOR LOCATIONS OF STEEL SHAPES AND INSERTS TO BE CAST WITH UNITS.
3. THE WEIGHT OF THE GROUTED UNITS AND TOPPING SHALL NOT BE GREATER THAN 75 PSF.
4. SEE "CONCRETE PLANK LOADING DIAGRAMS", THIS SHEET.
5. THE CONCRETE PLANK MANUFACTURER SHALL COORDINATE ALL FLOOR PENETRATIONS WITH ARCHITECTURAL, STRUCTURAL, MECHANICAL, ELECTRICAL, AND PLUMBING PLANS. PROVIDE ADDITIONAL REINFORCEMENT OR HEADERS AS REQUIRED TO FRAME AROUND ALL PENETRATIONS.
6. CONCRETE PLANKS ON FLOOR LEVELS SHALL BE TOPPED WITH 2" OF REGULAR WEIGHT CONCRETE ('C=3000PSI') AND REINFORCED WITH 6"x6"/W1.4xW1.4 W.W.F.
7. UNLESS SHOWN OTHERWISE PLANKS SHALL BEAR 3" MIN. PROVIDE HARDBOARD BEARING PAD FOR PLANKS BEARING ON CONCRETE OR MASONRY.

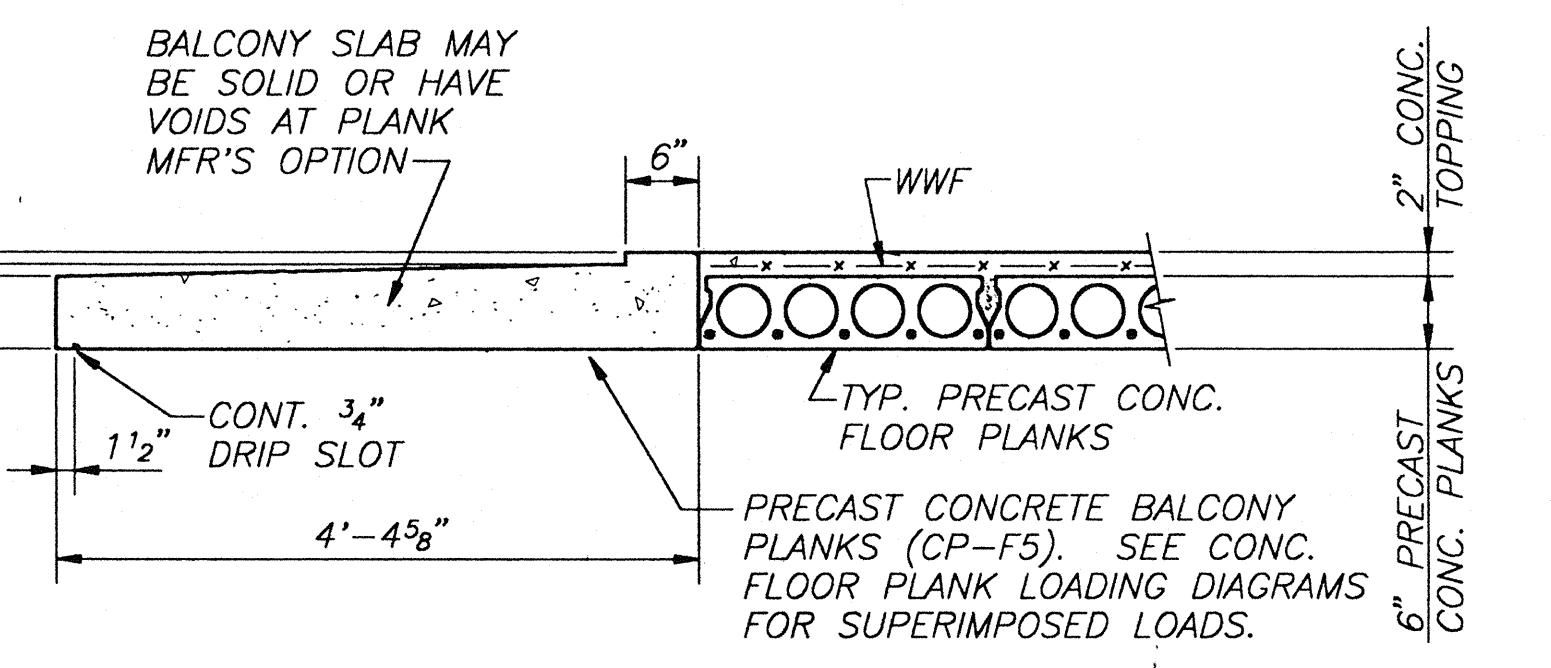

PRECOST CONCRETE
BALCONY PLANK


SECTION
 $\frac{1}{8}$ " = 1'-0"

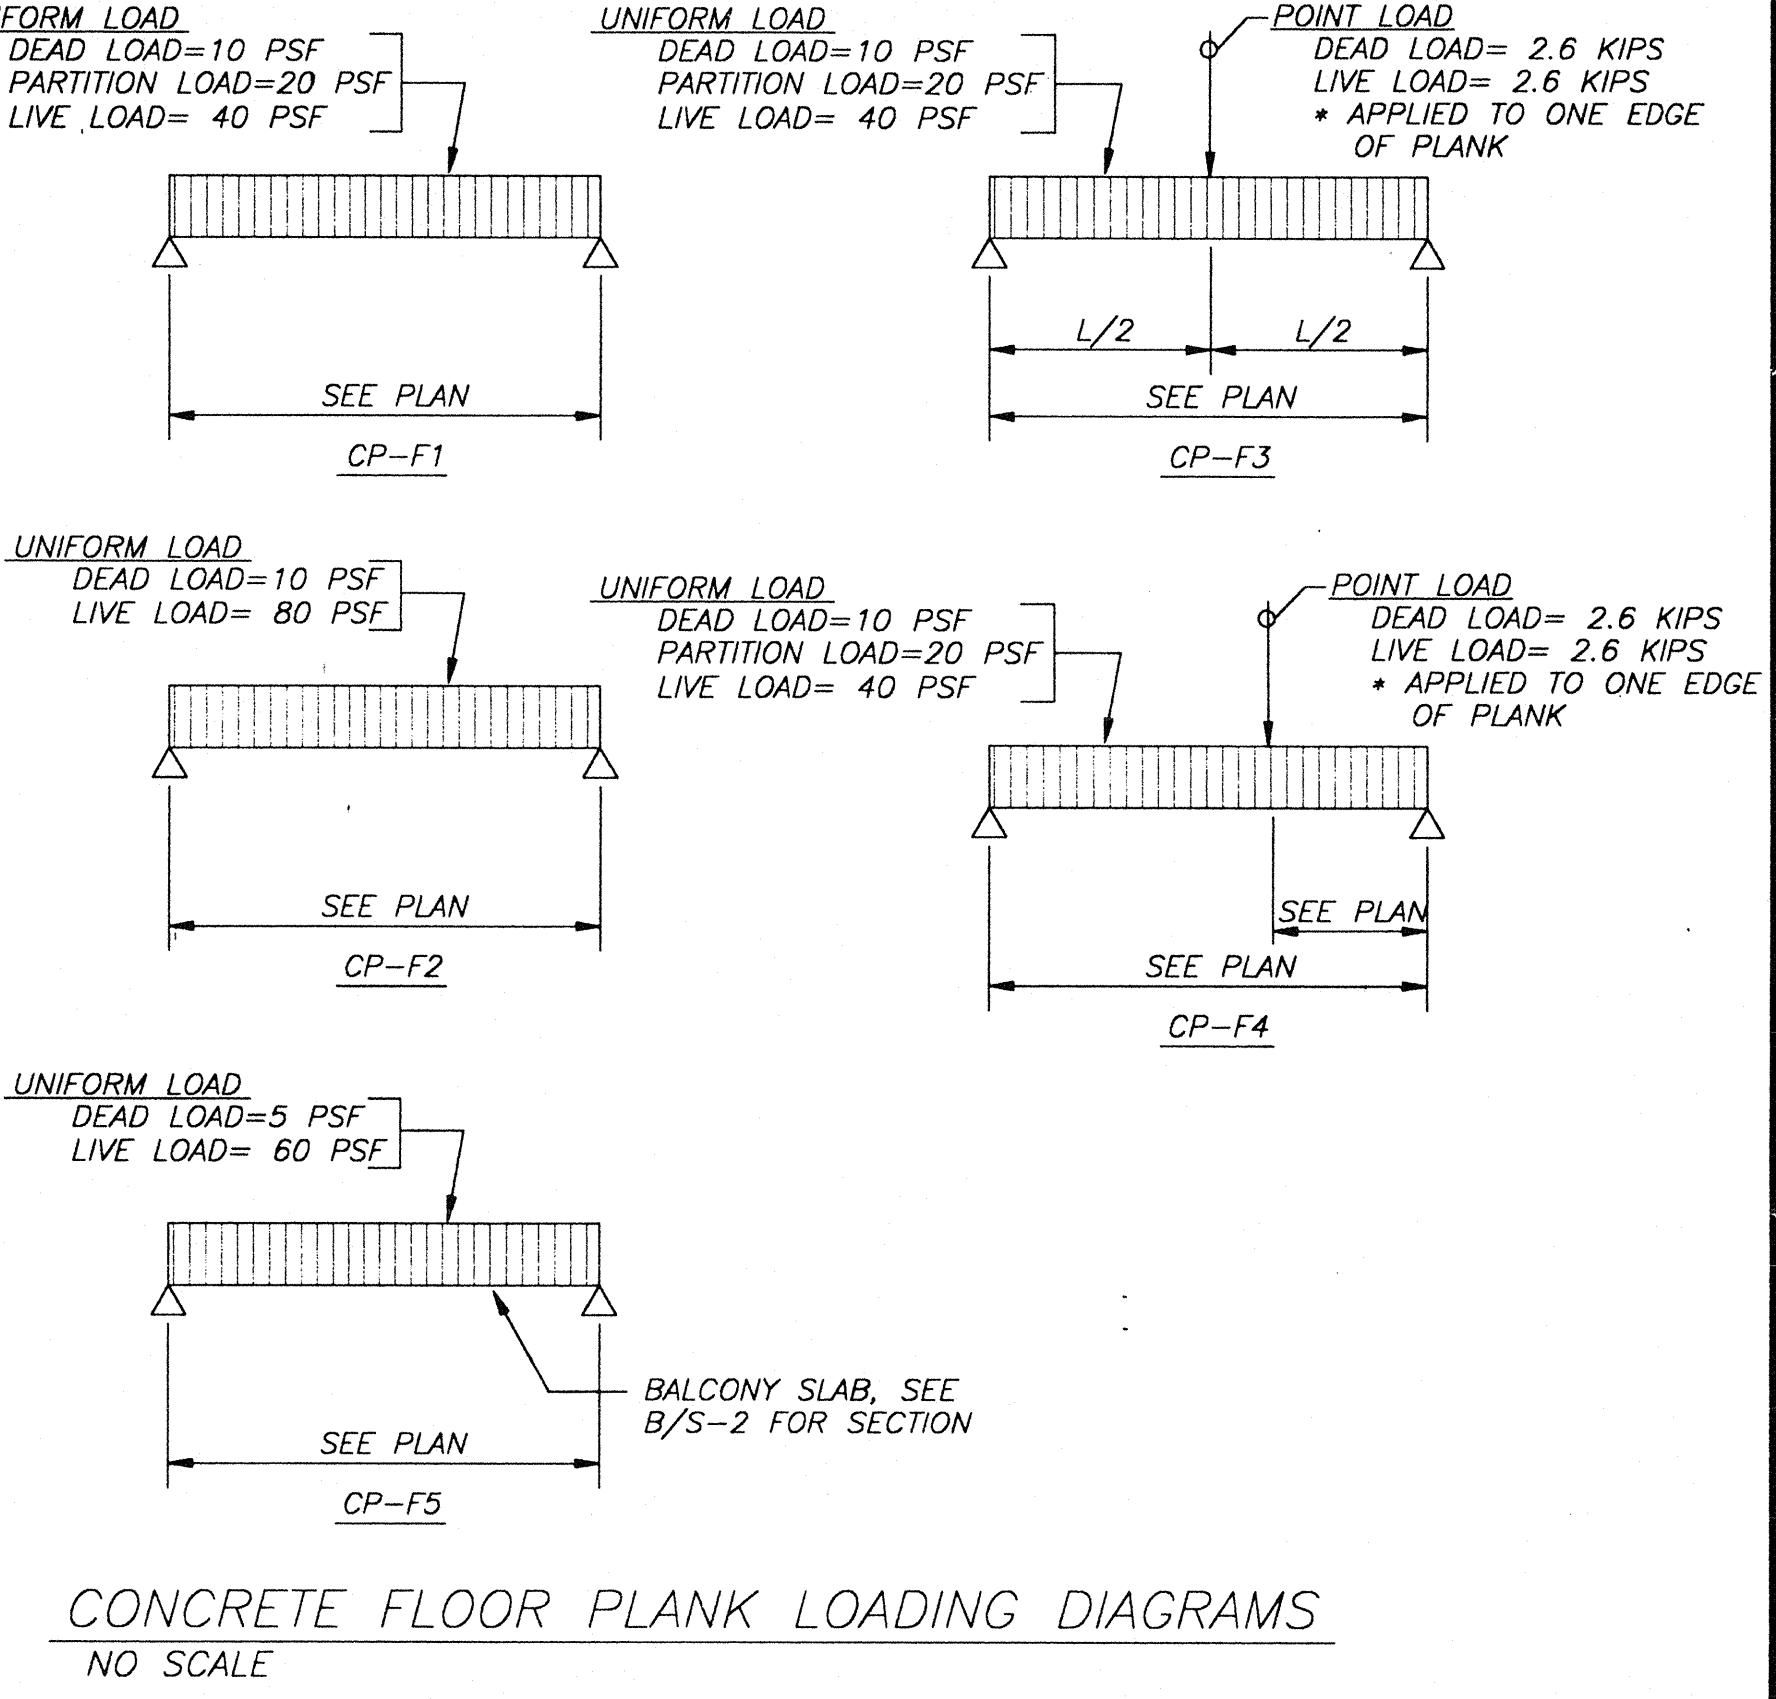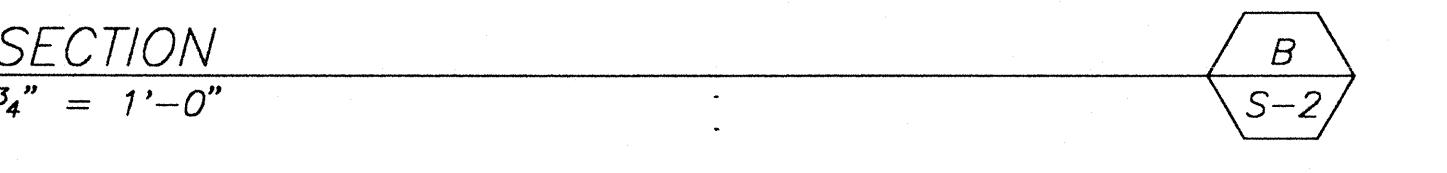

CONCRETE FLOOR PLANK LOADING DIAGRAMS
NO SCALE

NOTE: UNIFORM LOADS INDICATED ARE SUPERIMPOSED LOADS. THEY ARE IN ADDITION TO THE DEAD LOAD OF THE PLANKS.

POINT LOADS INDICATED ARE TOTAL LOADS APPLIED TO ONE SIDE OF THE PLANKS BY A STEEL HANGER.







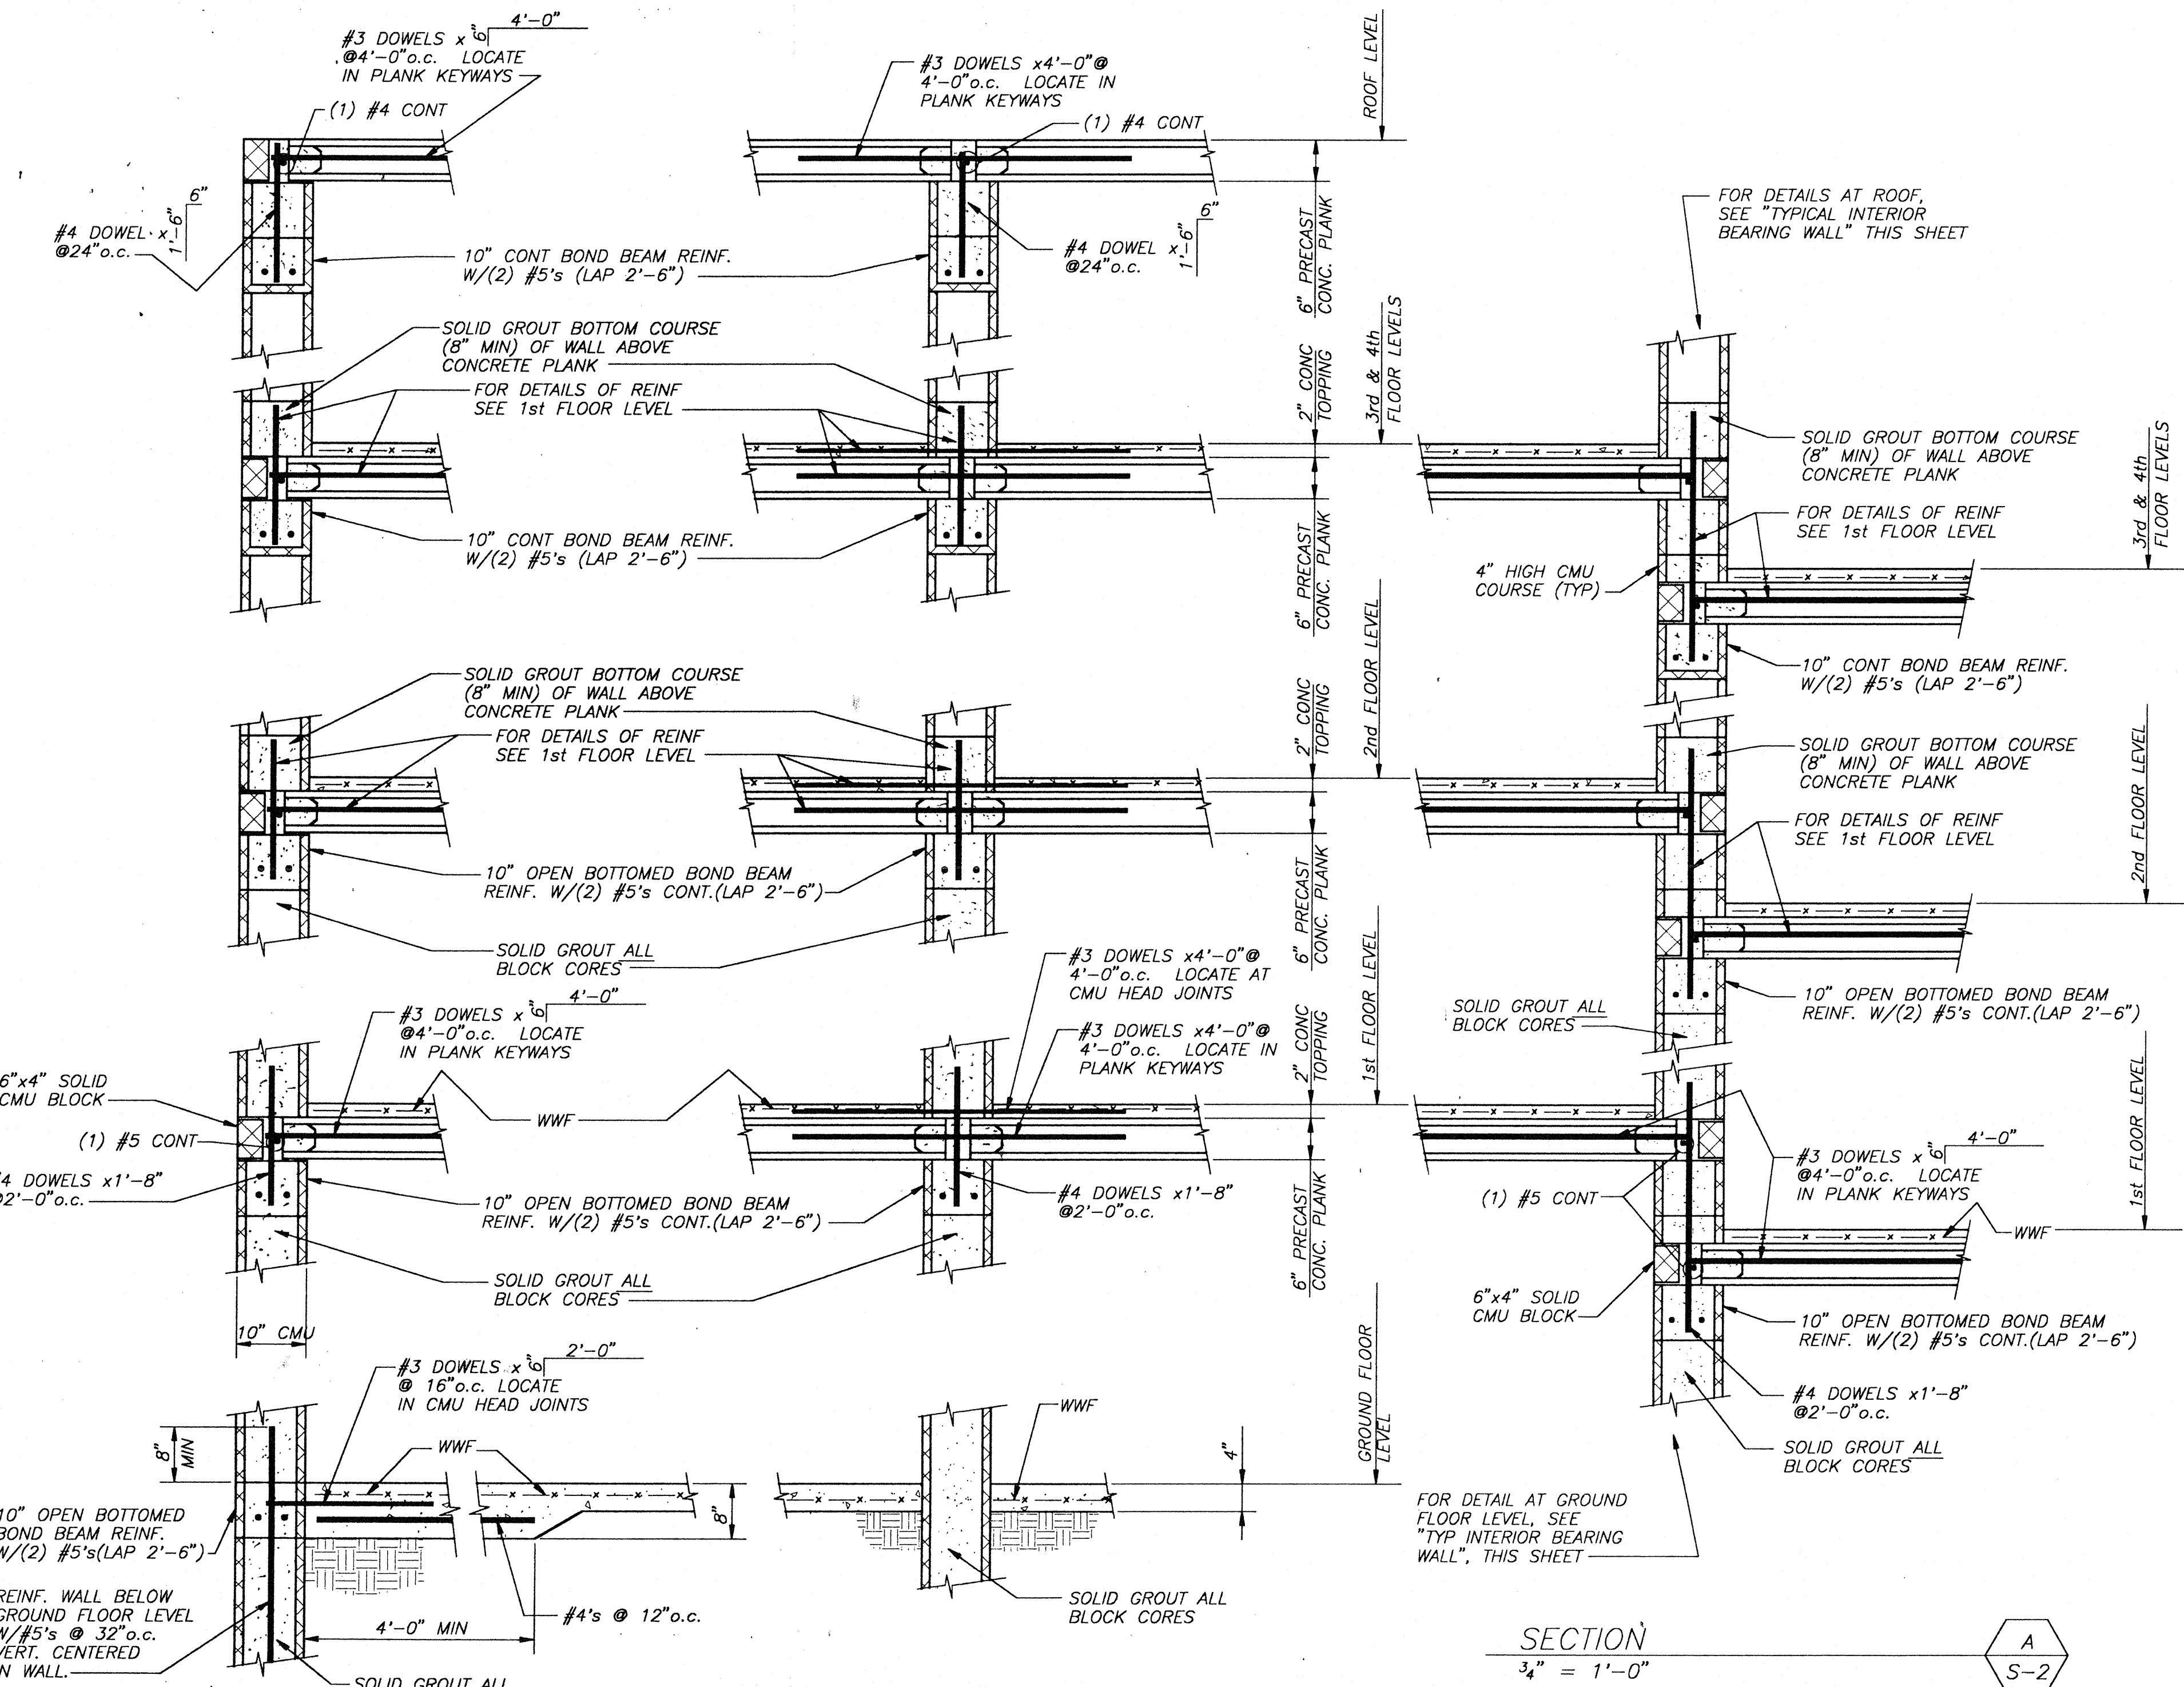


TYPICAL EXTERIOR
BEARING WALL
 $\frac{1}{8}$ " = 1'-0"

TYPICAL INTERIOR
BEARING WALL
 $\frac{1}{8}$ " = 1'-0"



$\frac{1}{8}$ " = 1'-0"

$\frac{1}{8}$ " = 1'-0"

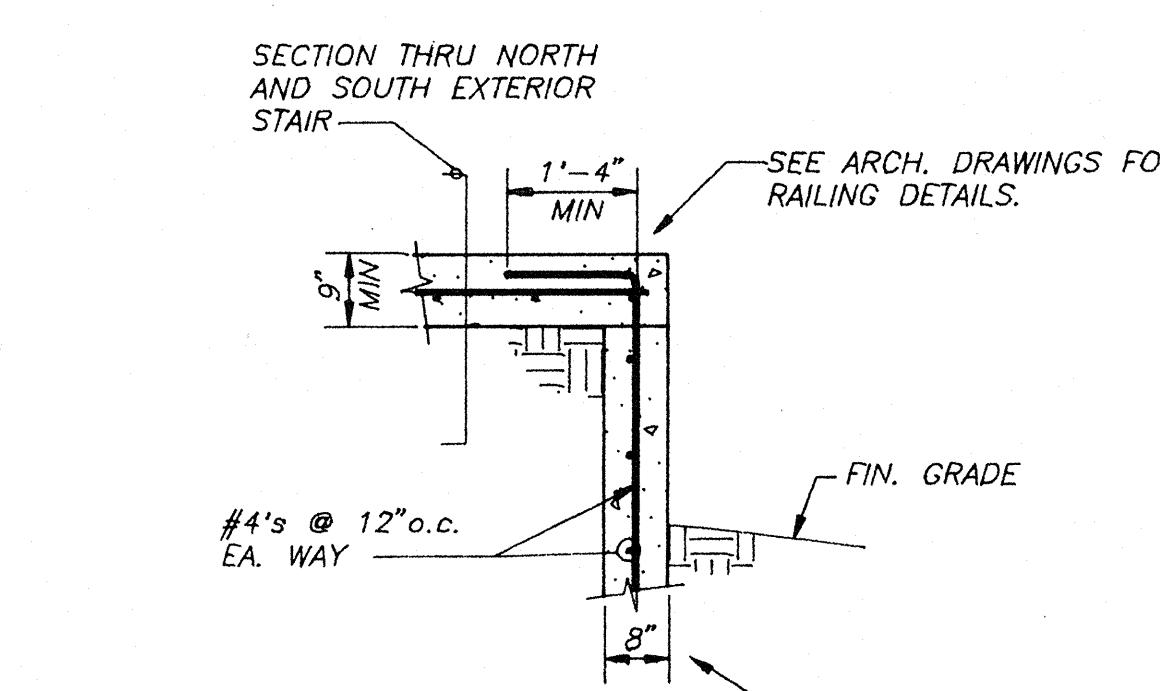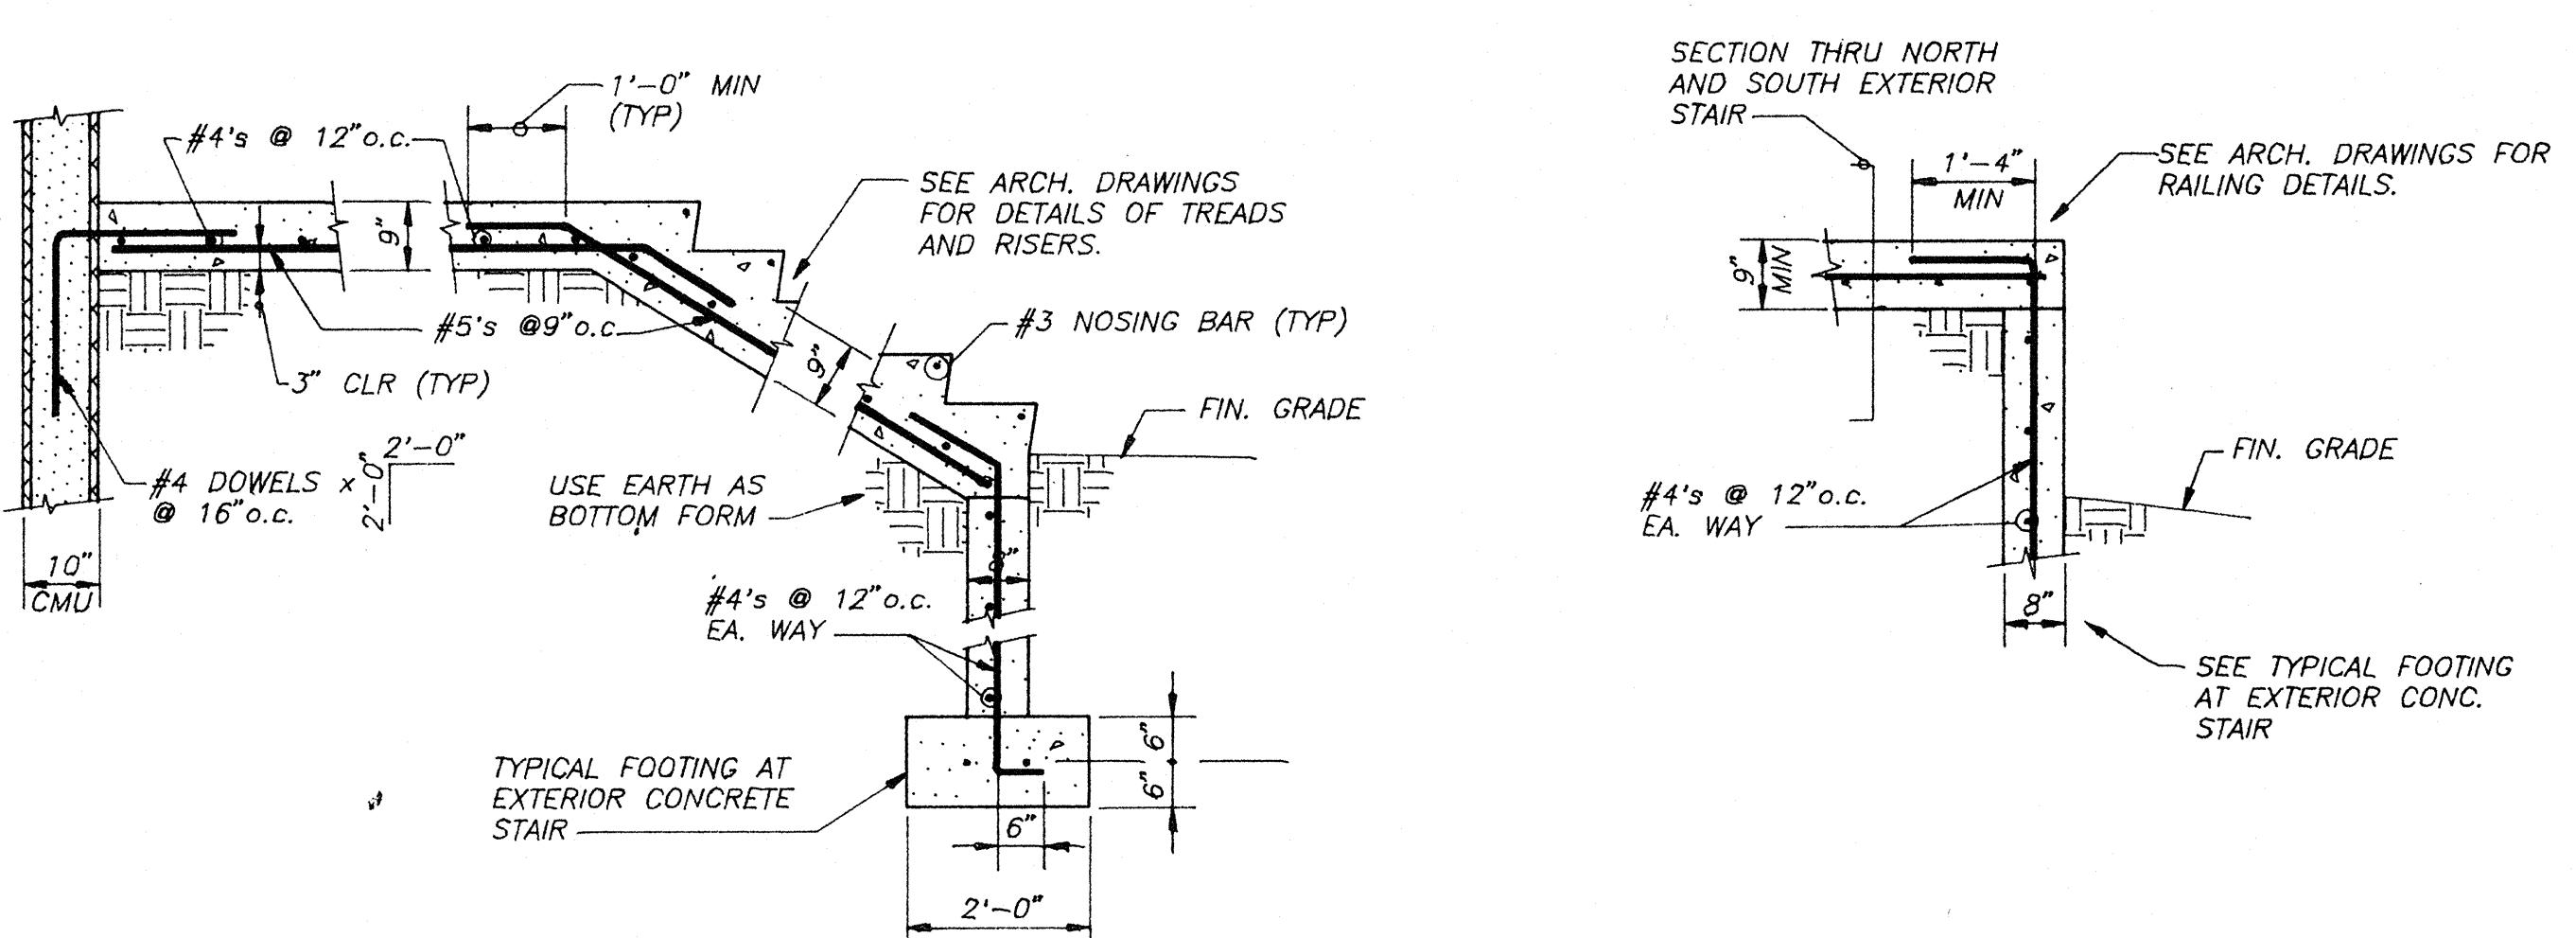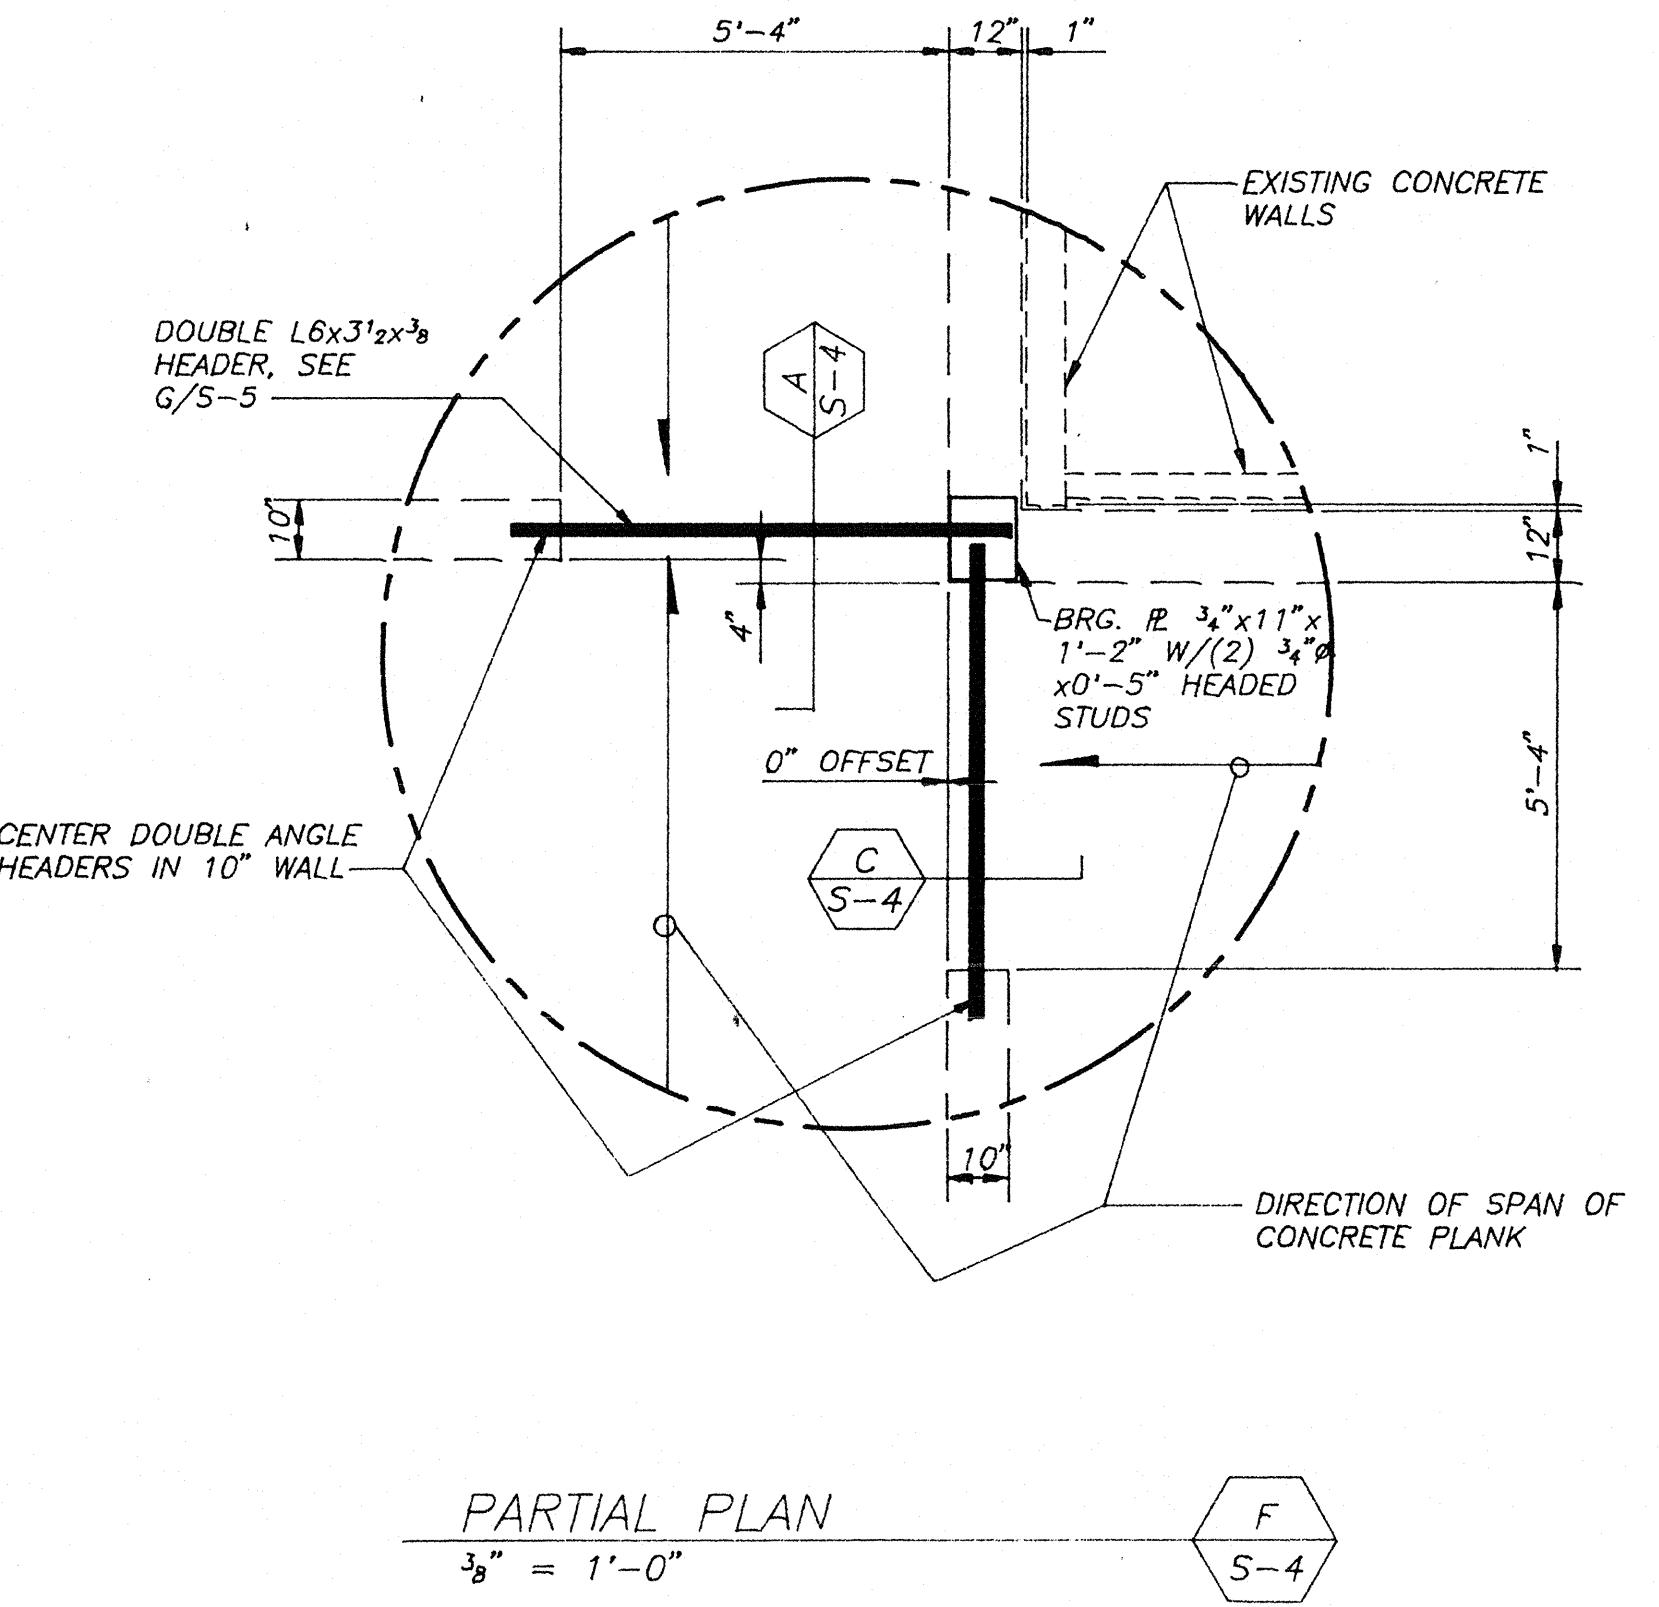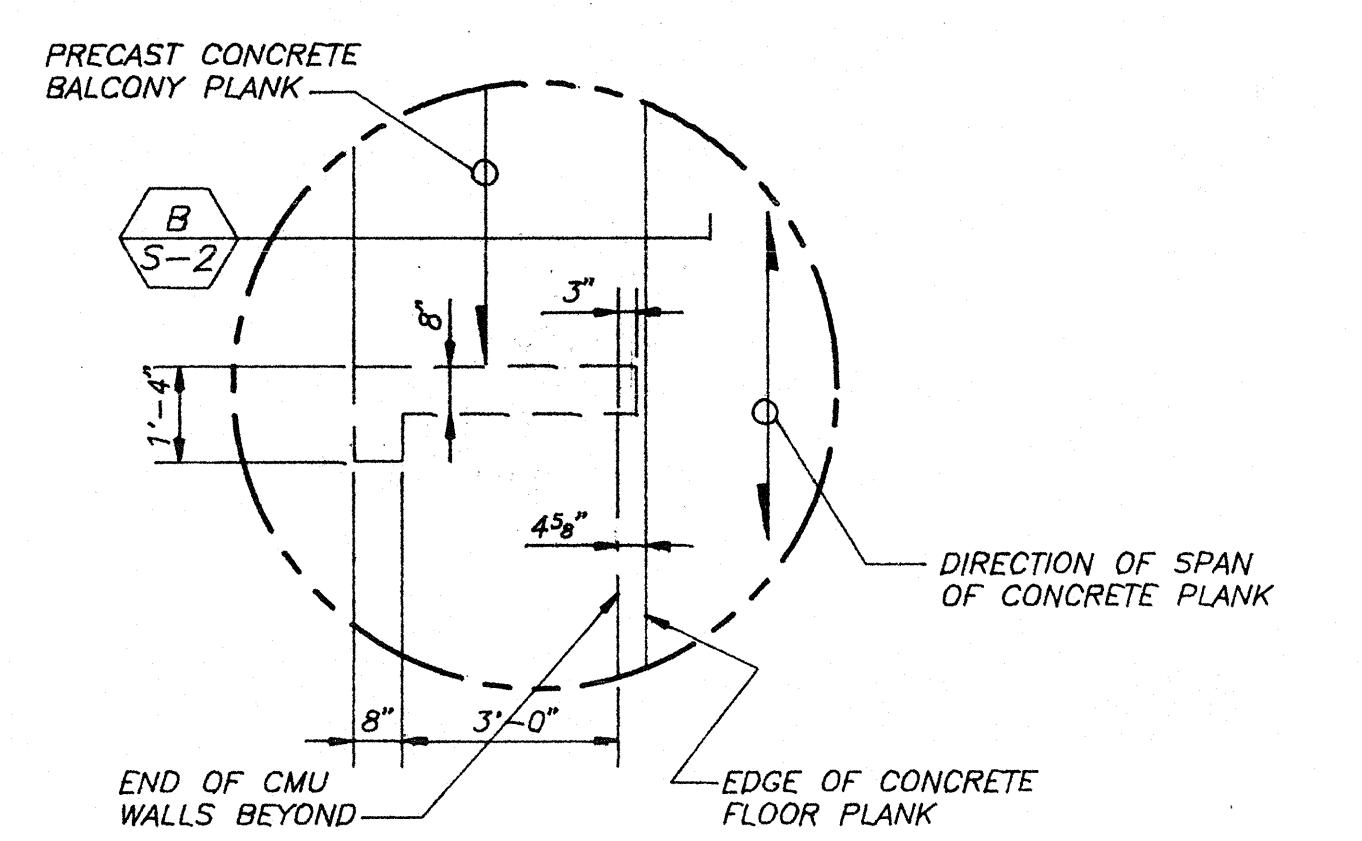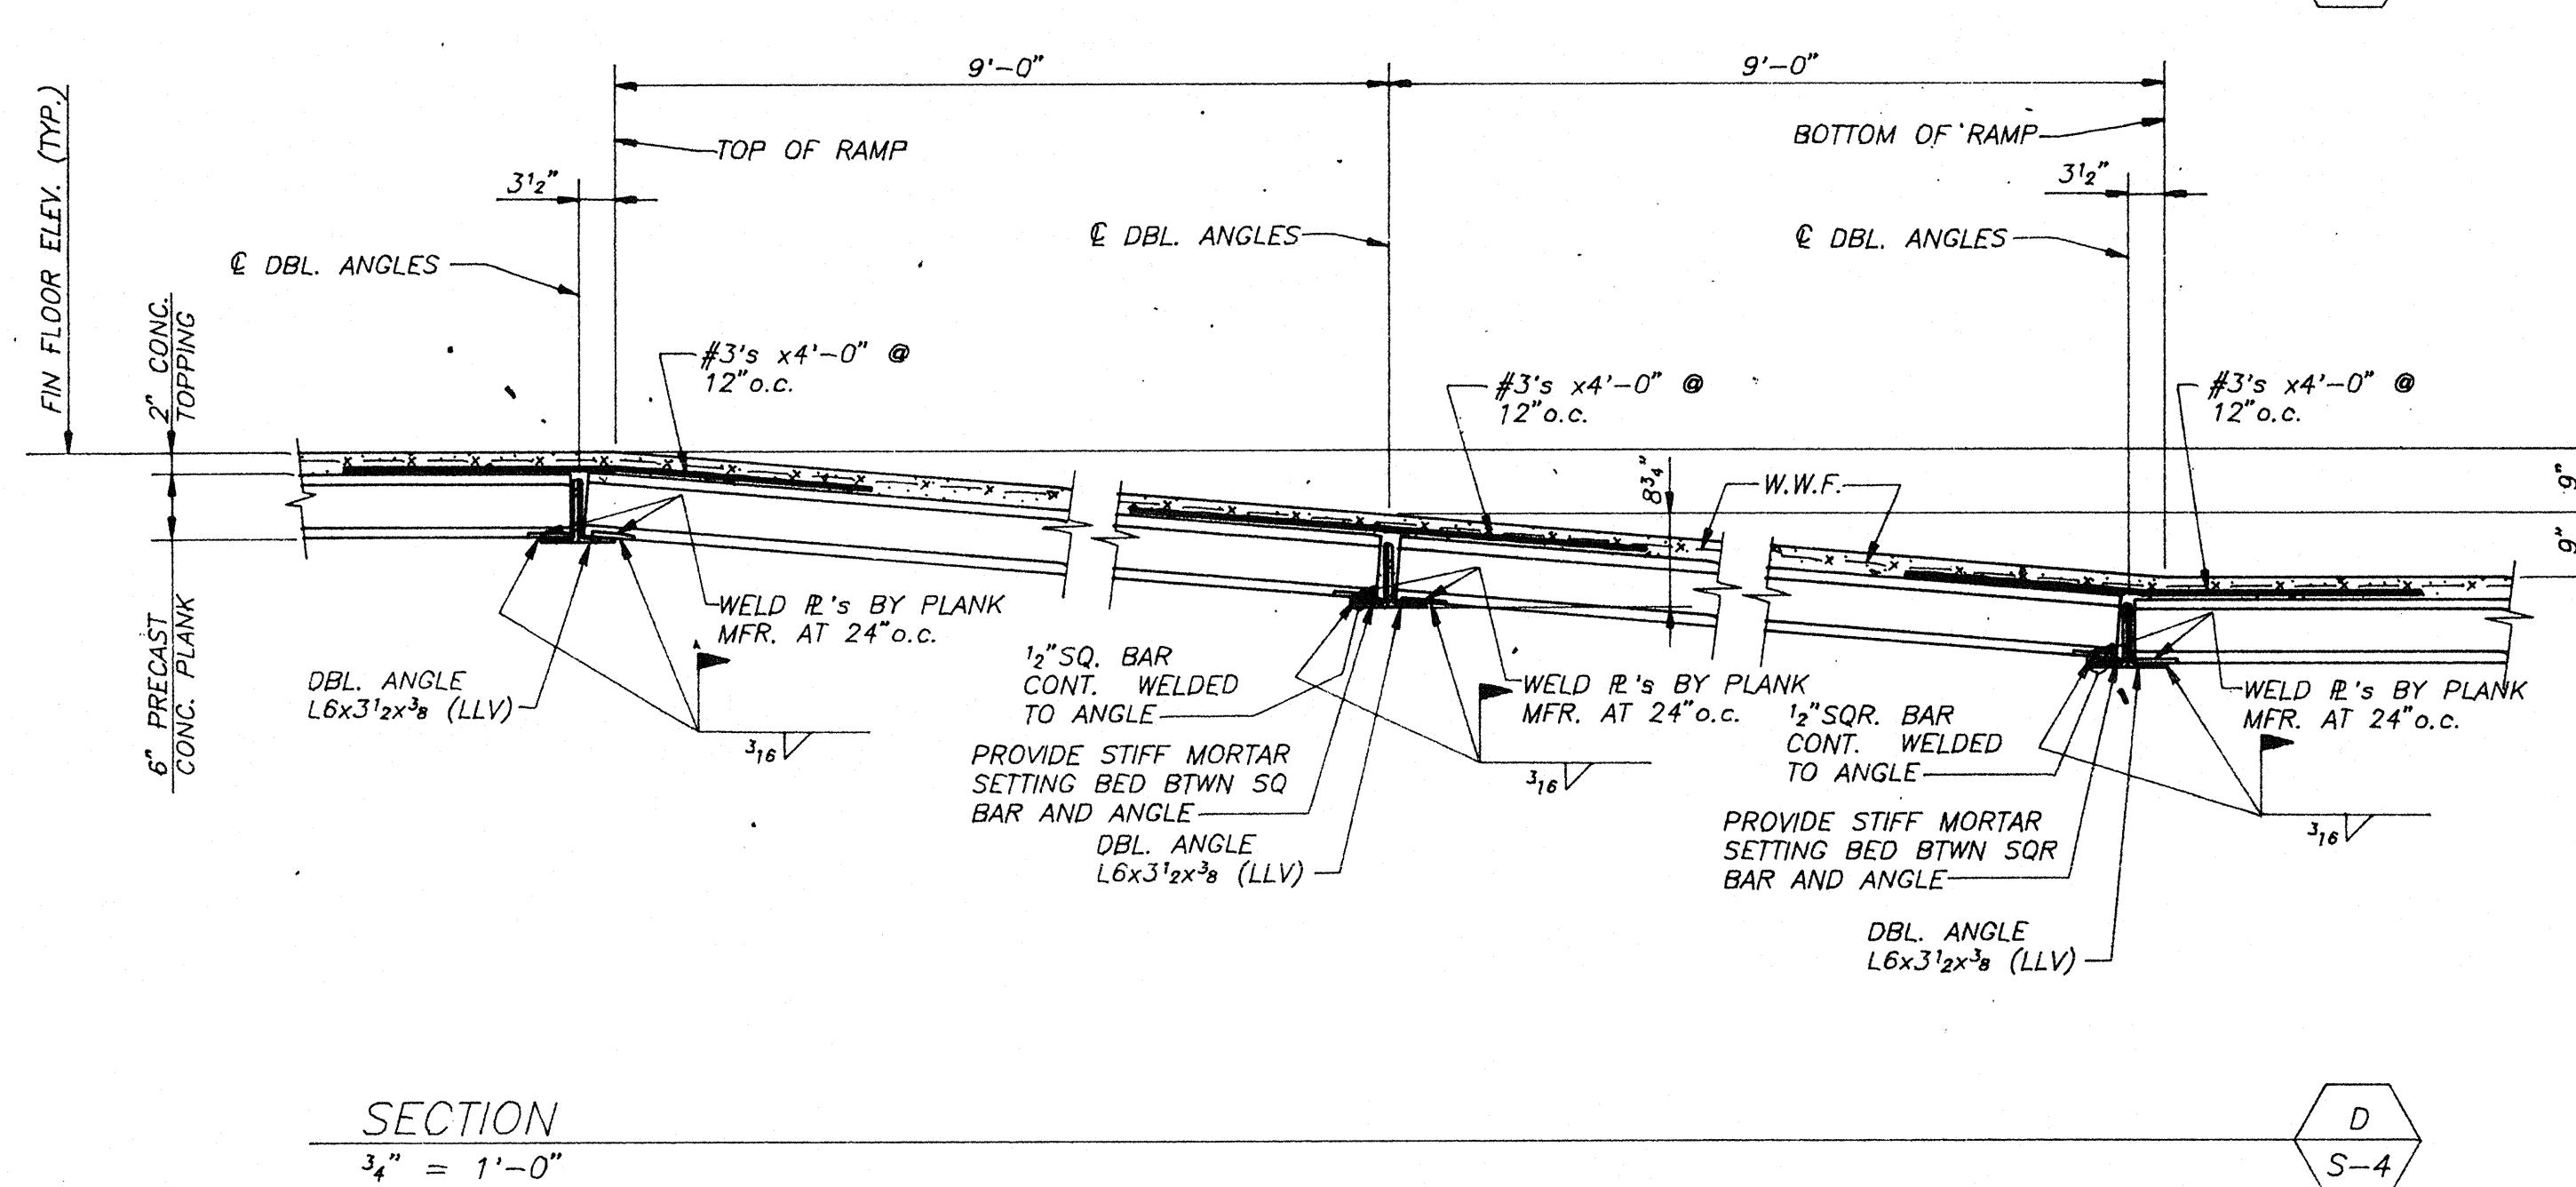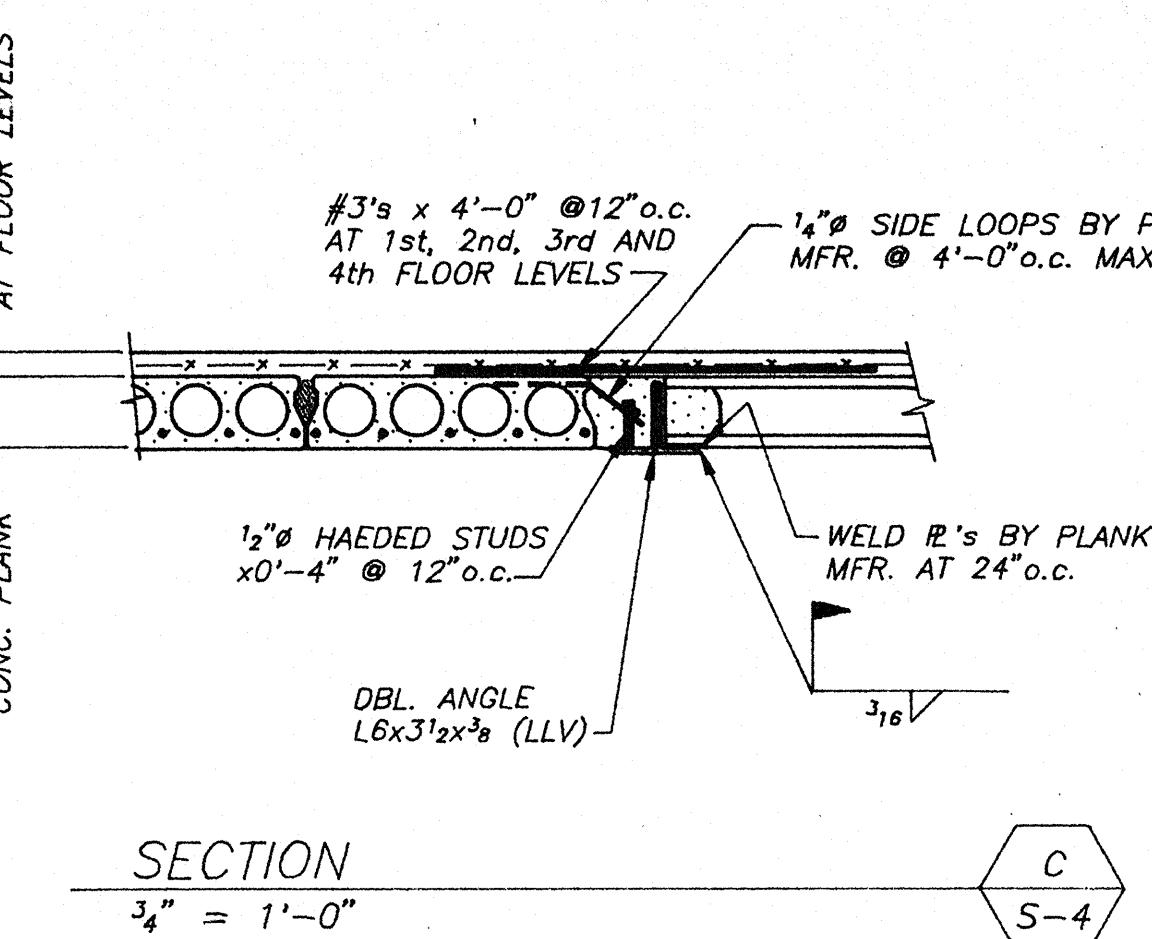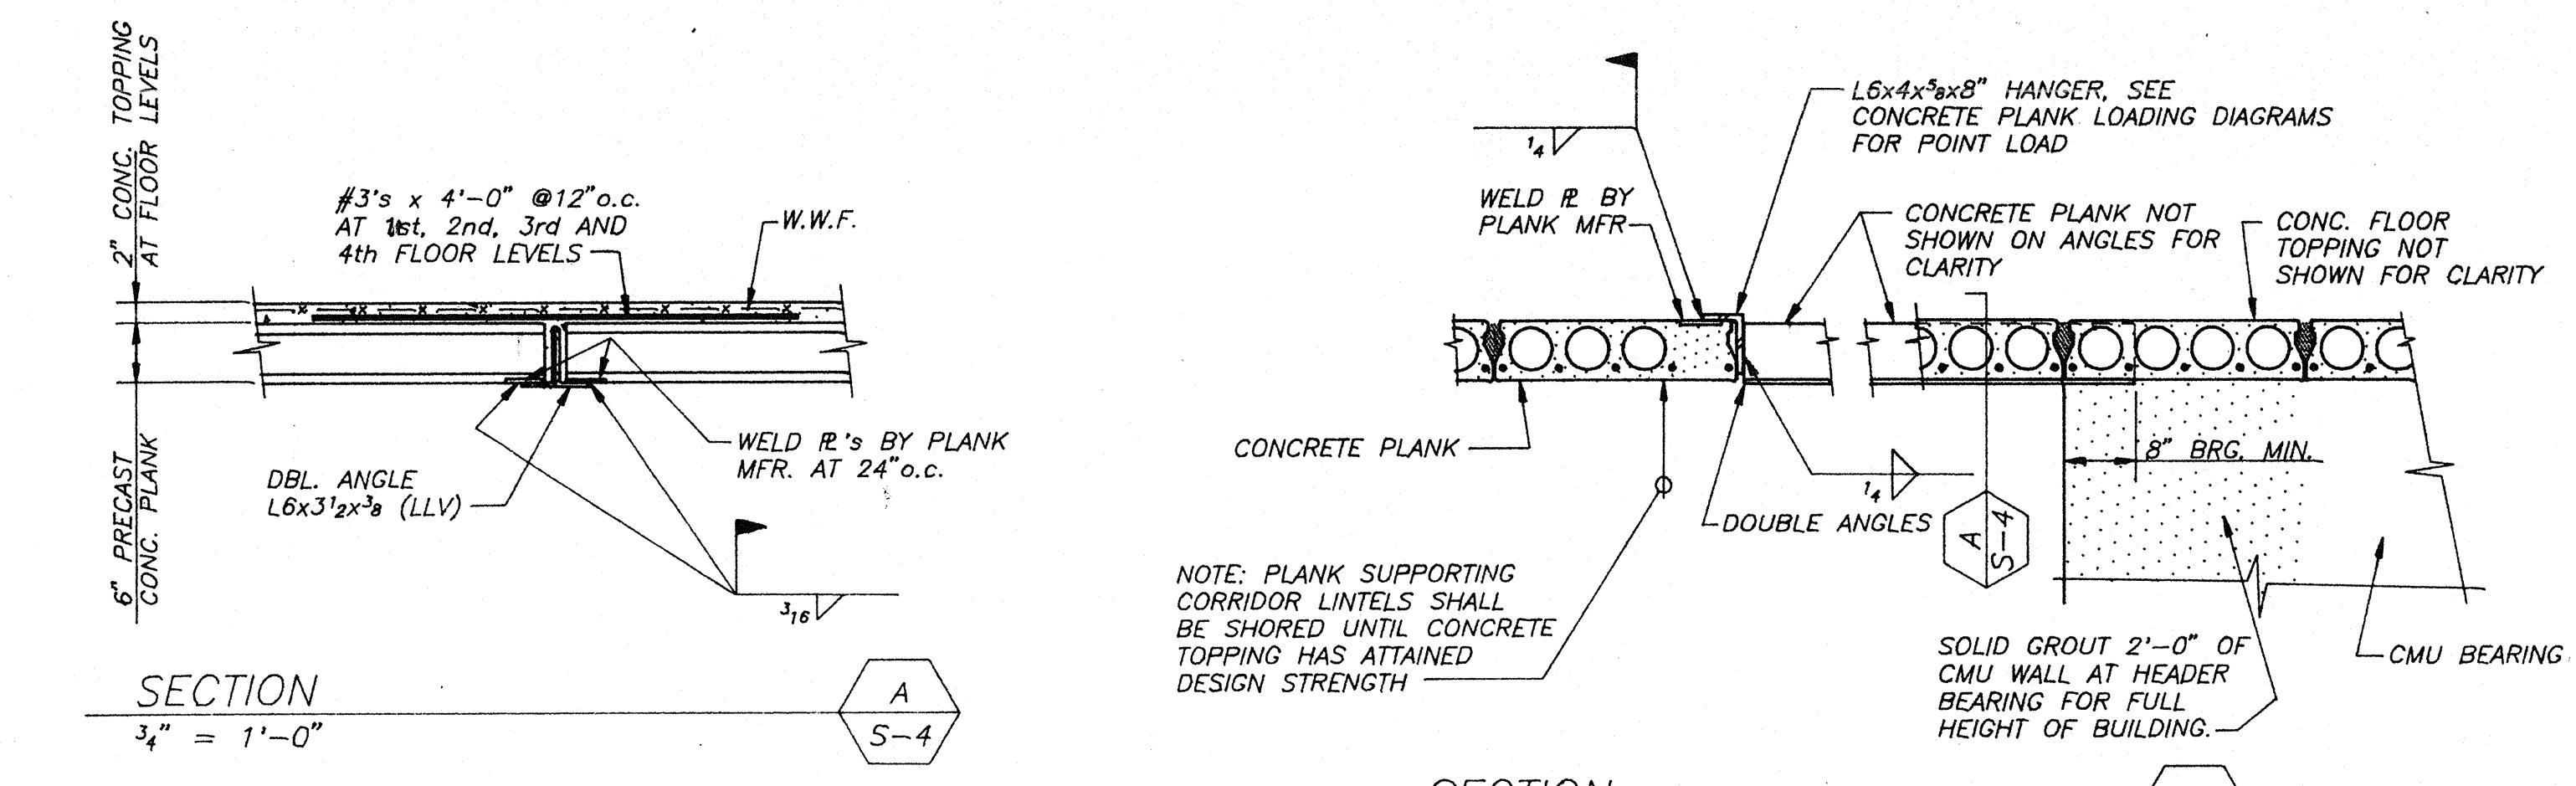

SECTION THRU NORTH AND SOUTH EXTERIOR STAIR
12" = 1'-0"

SECTION THRU SIDE WALL OF NORTH AND SOUTH EXTERIOR STAIR
12" = 1'-0"

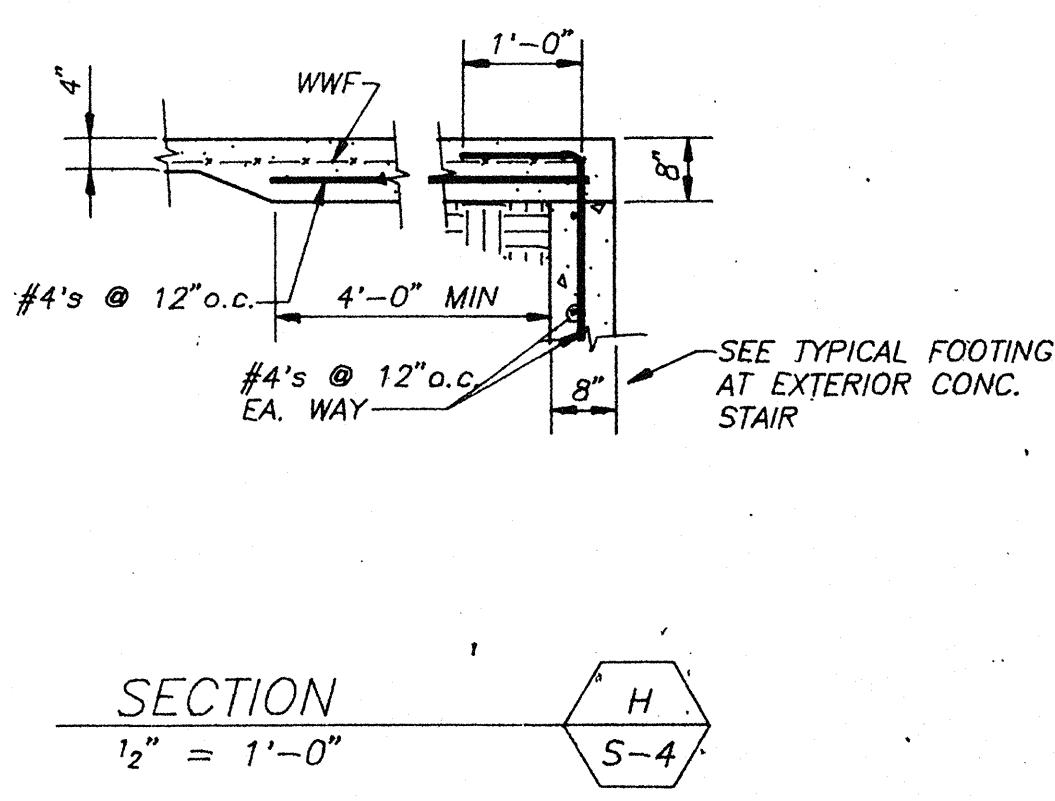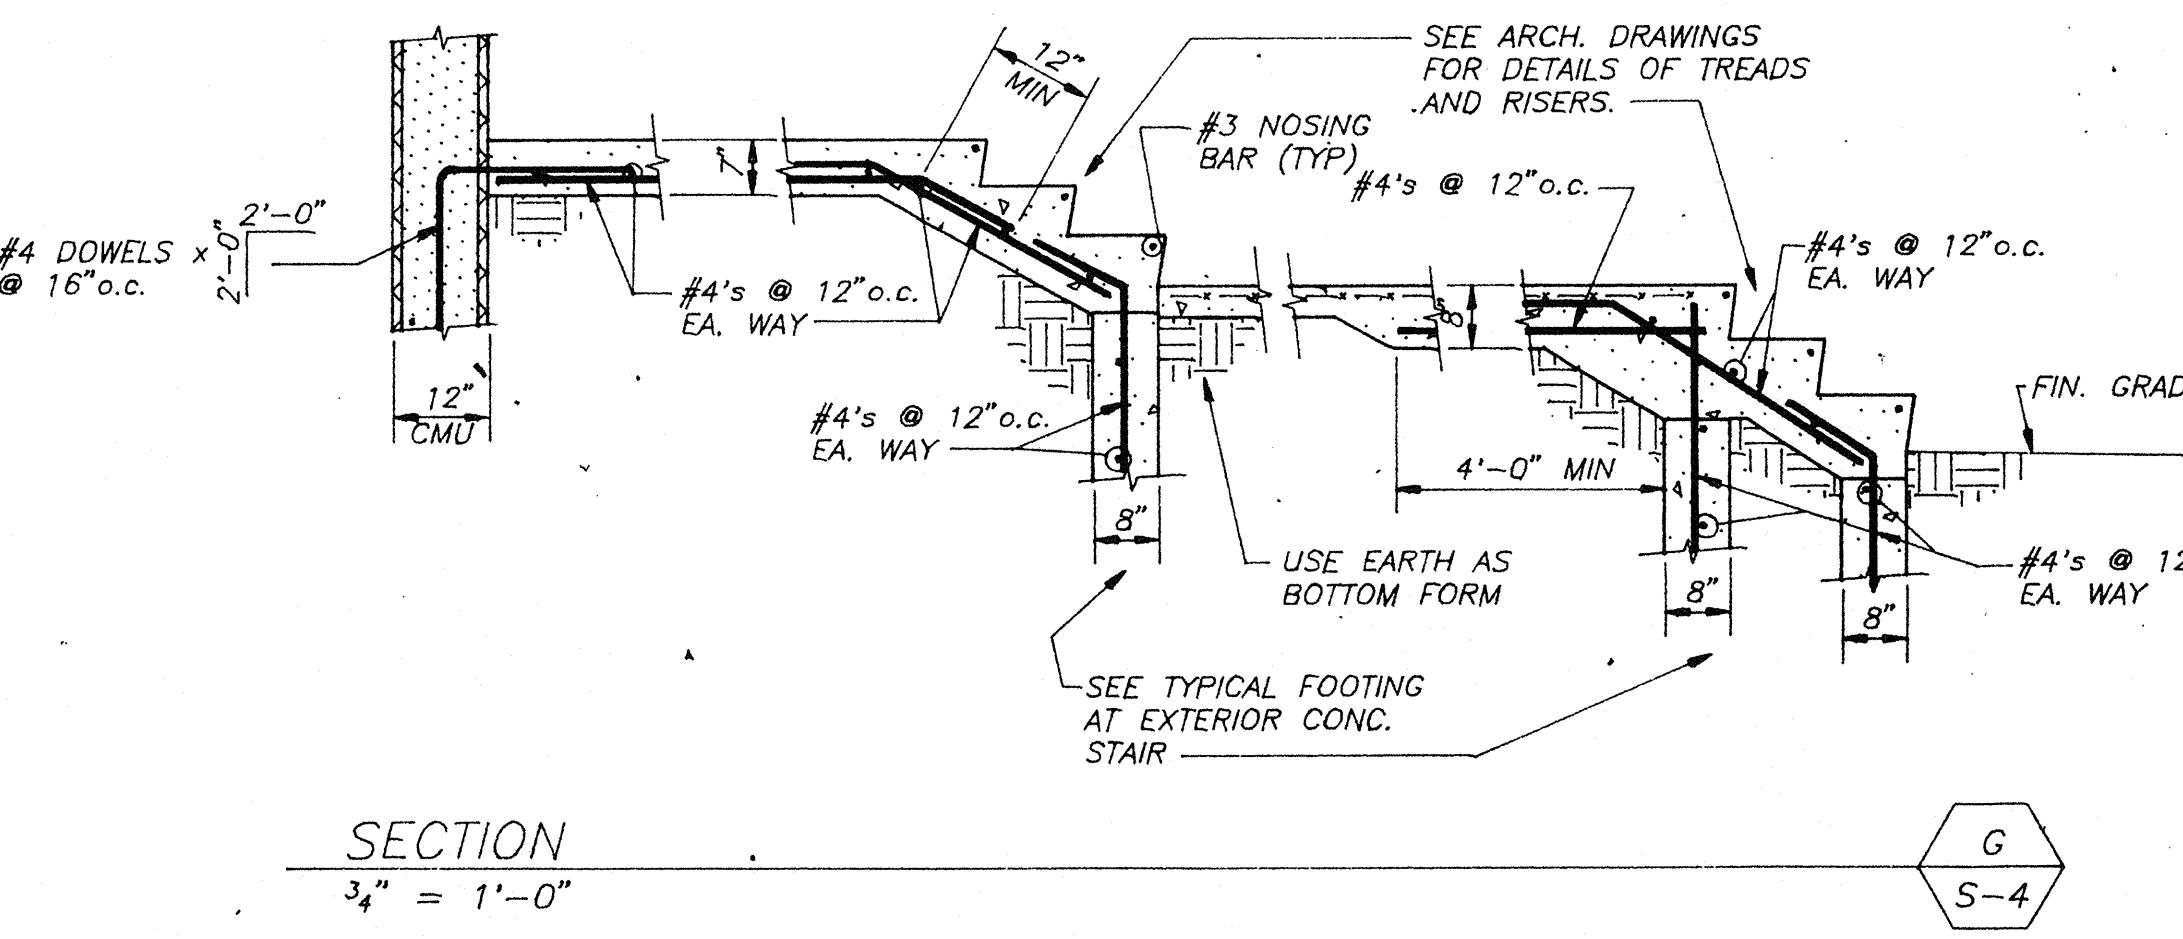

LINNEWEAVER APARTMENT ANNEX CORPORATION

HARRISONBURG, VIRGINIA

REVISIONS
DRAWN BY: RKH
DATE: 10/21/91
SHEET: S-4
COM: REvised

McCLINTOCK, MODSETT
AND ASSOCIATES, PC
ARCHITECTS and PLANNERS
HARRISONBURG, VIRGINIA

REVISIONS

(Handwritten notes and signatures)

DETAILS

SCALE: $\frac{3}{4}$ " = 1'-0"


LINNEWEAVER APARTMENT

McCLINTOCK, MODISSETT

AND ASSOCIATES, PC

ARCHITECTS and PLANNERS

HARRISONBURG, VIRGINIA

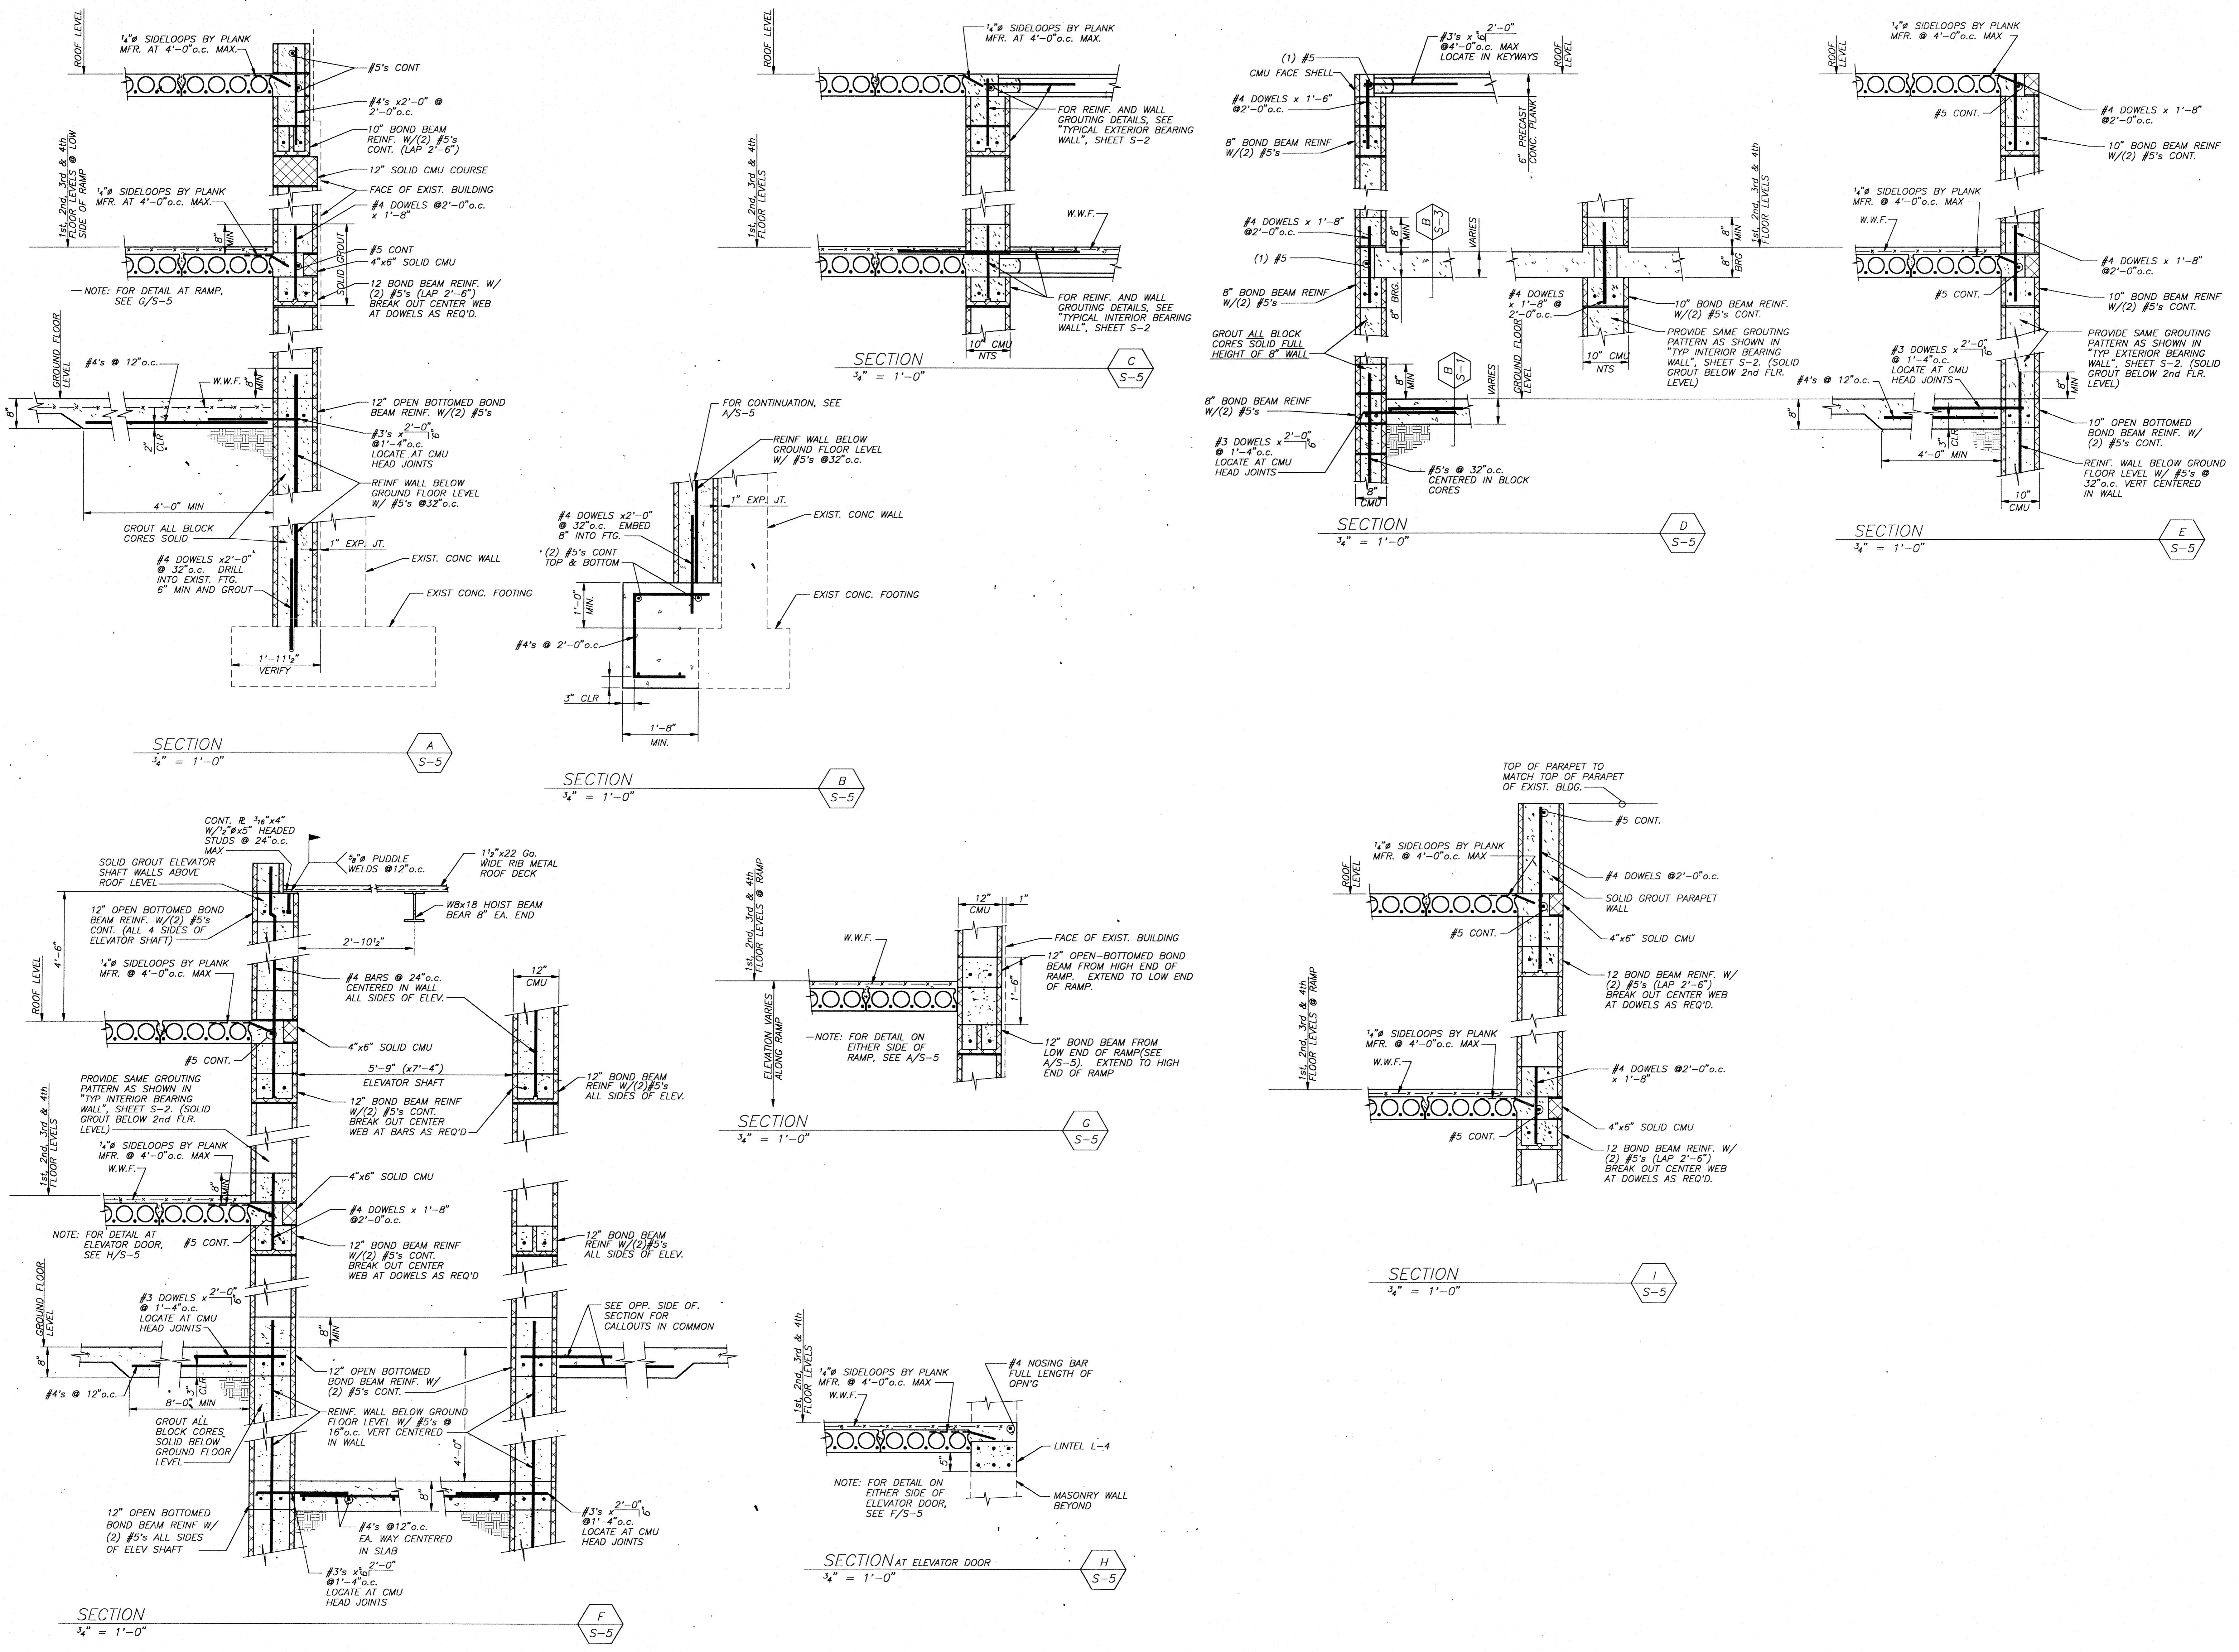

CON.
9110
SHEET
S-5
REVISED
DATE 10/21/91
DRAWN RKH
SHEET
S-5
DRAWN RKH